
# THE CUSTOM HOUSE PLAN NEW CONSTRUCTION

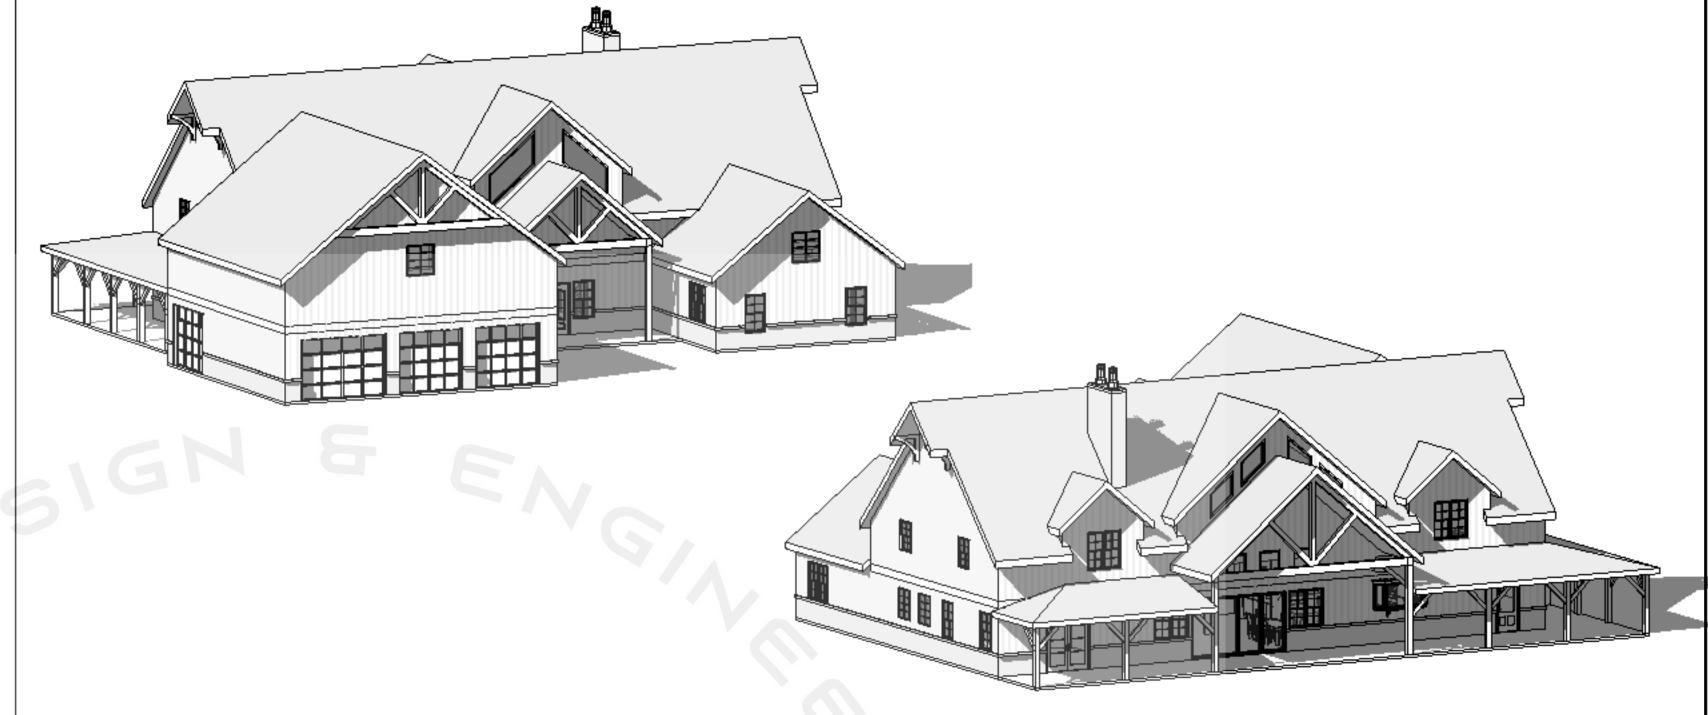

PROJECT DATA

# © COPYRIGHT BY RUMEL DESIGN \$ ENGINEERING ALL RIGHTS RESERVED. PLEASE NOTE: Rumel design & Engineering. assumes following before beginning construction: n field prior to proceeding with construction. Building Codes in the area the project is to be 3) Plans indicate locations only, building engineering on a Survey provided by Owners Consultant

# **GENERAL NOTE:**

1.THESE NOTES SHALL APPLY TO ALL DRAWINGS UNLESS NOTED OTHERWISE OR SHOWN. FEATURES OF CONSTRUCTION SHOWN ARE TYPICAL AND THEY SHALL APPLY GENERALLY THROUGHOUT SIMILAR CONDITIONS. ALL OMISSIONS OR CONFLICTS BETWEEN VARIOUS ELEMENTS OF THE DRAWINGS AND/OR GENERAL NOTES SHALL BE BROUGHT TO THE ATTENTION OF THE ARHCITECT/ ENGINEER BY THE CONTRACTOR /BUILDER BEFORE

2. ALL CONSTRUCTION SHALL CONFORM TO THE MINIMUM STANDARDS OF THE NTERNATIONAL BUILDING CODE (IBC) AND ALL LOCAL CODES PRESENTLY IN EFFECT UNLESS MORE STRINGENT REQUIREMENTS ARE INDICATED.

FOR ALL CONSTRUCTION MEANS, METHODS, TECHNIQUES, SEQUENCES AND QUALITY CONTROL AND IN ACHIEVING CONFORMANCE WITH CONTRACT DRAWINGS AND SPECIFICATIONS, AND THEREFORE THEY DO NOT GUARANTEE CONTRACTOR'S PERFORMANCE AND SHALL NOT BE CONSTRUED AS SUPERVISION OF CONSTRUCTION.

4. ANYONE SUPPLYING LABOR AND/OR MATERIALS TO THE PROJECT SHALL CAREFULLY EXAMINE ALL SUBSURFACES TO RECEIVE WORK, ANY CONDITIONS DETRIMENTAL TO WORK SHALL BE REPORTED IN WRITING TO THE CONTRACTOR PRIOR TO BEGINNING WORK. COMMENCEMENT OF WORK SHALL IMPLY ACCEPTANCE OF ALL SUBSURFACES.

5. ANY MATERIALS STORED AT THE SITE SHALL BE COMPLETELY SUPPORTED FREE OF THE GROUND, COVERED AND OTHERWISE PROTECTED TO AVOID DAMAGE FROM THE

6. THE CONTRACTOR /BUILDER SHALL OBTAIN AND PAY FOR ALL REQUIRED PERMITS, LICENSES, AND ALL UTILITY CHARGES, AND ARRANGE FOR ALL REQUIRED INSPECTIONS.

7. THE CONTRACTOR /BUILDER SHALL BE RESPONSIBLE FOR COORDINATING BUILDING & SITE UTILITIES BETWEEN ARCHITECTURE, CIVIL & MEP DRAWINGS. THE CONTRACTOR SHALL ALSO CONTACT ALL APPLICABLE UTILITY COMPANIES & PROVIDE CONDUIT & OTHER FACILITIES AS REQUIRED.

8. THE CONTRACTOR /BUILDER SHALL VERIFY ALL DIMENSIONS & CONDITIONS ON THE JOB SITE PRIOR TO THE CONSTRUCTION. THE CONTRACTOR SHALL NOTIFY THE ARCHITECT IMMEDIATELY OF ANY DISCREPANCIES. IN CASES OF DISCREPANCY CONCERNING DIMENSIONS, QUANTITIES AND LOCATION. THE CONTRACTOR SHALL, IN WRITING, CALL TO THE ATTENTION OF THE ARCHITECT ANY DISCREPANCIES BETWEEN SPECIFICATIONS, PLANS, DETAILS OR SCHEDULES. THE ARCHITECT WILL THEN INFORM THE CONTRACTOR, IN WRITING, WHICH DOCUMENT TAKES

PRECEDENCE. THERE SHALL BE NO ADJUSTMENT TO THE COST OR TIME OF THE WORK

RESULTING FROM CLARIFICATION OF SUCH DISCREPANCIES. 9. DIMENSIONS ON DRAWINGS ARE SHOWN TO FINISHED FACE OF WALLS AND PARTITIONS OF EXISTING OR NEW CONSTRUCTION UNLESS NOTED OTHERWISE. CEILING HEIGHT DIMENSIONS AND ALL OTHER VERTICAL DIMENSIONS ARE TO THE FINISHED FLOOR

10. ALL MATERIALS SPECIFIED OR NOTED SHALL BE INSTALLED IN ACCORDANCE WITH THE

SURFACE UNLESS NOTED OTHERWISE

11. THE CONTRACTOR /BUILDER SHALL BE RESPONSIBLE FOR SUBMITTING SHOP DRAWINGS, PRODUCT DATA, OR SAMPLES FOR CASEWORK, FINISHES, DOORS, FRAMES, HARDWARE, MECHANICAL, ELECTRICAL, AND PLUMBING FIXTURES, AND OTHER ITEMS REQUIRING ARCHITECT'S OR CLIENT'S REVIEW FOR CONFORMANCE WITH THE CONTRACT DOCUMENTS, AND FOR ALL ITEMS WHICH ALLOWED CONTRACTOR OPTIONS. PRIOR TO FORWARDING TO THE ARCHITECT FOR REVIEW. THESE SUBMITTALS MUST BE REVIEWED BY THE CONTRACTOR FOR CONFORMANCE WITH THE MEANS, METHODS, TECHNIQUES, SEQUENCES, AND OPERATIONS OF CONSTRUCTION AND SAFETY PRECAUTIONS AND PROGRAMS INCIDENTAL THERETO, ALL OF WHICH ARE THE SOLE RESPONSIBILITY OF THE CONTRACTOR /BUILDER. THE CONTRACTOR /BUILDER SHALL AFFIX A STAMP TO SUBMITTAL INDICATING HIS REVIEW. SUBMITTALS FORWARDED WITHOUT A STAMP WILL BE RETURNED. ALL SUBMITTALS MUST BE REVIEWED BY THE ARCHITECT PRIOR TO CONSTRUCTION.

12. CONTRACTOR SHALL GUARANTEE ALL WORK AGAINST FAULT OF ANY MATERIAL OR WORKMANSHIP FOR A PERIOD OF NOT LESS THAN ONE YEAR AFTER COMPLETION OR ACCEPTANCE. FAULTY WORK SHALL BE REPLACED OR REPAIRED AS REQUIRED AT NO COST TO THE OWNER.

13. CONTRACTOR SHALL COORDINATE WITH OWNER ALL ITEMS TO BE SALVAGED PRIOR TO SUBMISSION OF BIDS AND START OF CONSTRUCTION. OWNER SHALL HAVE SALVAGE RIGHTS TO RETAIN ALL REMOVED ITEMS.

14. ALL CHANGES PROPOSED DURING CONSTRUCTION WHICH RESULT IN A CHANGE TO THE CONTRACT TIME AND/OR SUM SHALL BE SUBMITTED TO THE ARCHITECT IN WRITING AND APPROVED BY THE ARCHITECT AND OWNER BEFORE SUCH WORK SHALL COMMENCE.

15. CONTRACTOR SHALL COORDINATE CLEAR OPENINGS FOR ALL APPLIANCES PRIOR TO CONSTRUCTION OF CASEWORK.

16. CONTRACTOR SHALL FURNISH AND INSTALL CONCEALED FIRE-RETARDANT TREATED WOOD BLOCKING BEHIND ALL CABINETS, TOILET ACCESSORIES, PLUMBING FIXTURES, AND OTHER WALL MOUNTED ITEMS AS REQUIRED FOR ADEQUATE SUPPORT.

17. CONTRACTOR SHALL COORDINATE ALL LOCK AND LATCH SETS AND FINAL KEYING WITH OWNER. DOUBLE KEYED LOCKS ARE NOT PERMITTED ON ANY REQUIRED OR MARKED EXIT. MATCH EXISTING KEYING SYSTEM IF ONE IS EXISTING.

18. ALL DOOR HARDWARE ON EXIT DOORS SHALL BE READILY OPERABLE FROM THE EGRESS SIDE WITHOUT THE USE OF A KEY, SPECIAL KNOWLEDGE, OR EFFORT.

SYMBOLS:

TO RECEIVE NEW FINISHES IN ACCORDANCE WITH THE MANUFACTURER'S RECOMMENDATIONS FOR THE SUBSTRATE & FINISH BEING APPLIED.

20. CONTRACTOR SHALL BE RESPONSIBLE FOR PROTECTION OF ALL EXISTING CONSTRUCTION INDICATED TO REMAIN AND SHALL REPAIR AND/OR REPLACE ALL AREAS AND/OR MATERIALS DAMAGED DURING CONSTRUCTION AT A MINIMUM TO THE CONDITION WHICH

21. ALL NEW GLASS AND GLAZING LOCATED IN HAZARDOUS LOCATIONS AS DEFINED IN IBC SECTION 2406.3 SHALL MEET THE REQUIREMENTS FOR SAFETY GLAZING AS DEFINED IN IBC

22. IF THE CONTRACTOR /BUILDER FAILS TO SUBMIT A MATERIAL FOR APPROVAL, THE MATERIAL MAY BE REQUIRED TO BE REMOVED BY HIM EITHER BY DIRECTION OF THE


23. THE CONTRACTOR /BUILDER IS TO PROVIDE AS BUILT DRAWINGS IN HARD COPY & AN

24. INSTALL ELASTOMERIC JOINT SEALER AROUND ALL PIPES. DUCTWORK, & STRUCTURE PASSING THRU INTERIOR NON-RATED CONCRETE AND MASONRY WALLS, GYPSUM BOARD AND MASONRY WALLS, GYPSUM BOARD PARTITIONS, AND CONCRETE FLOOR/ROOF SLABS SEAL ALL PIPES, DUCTWORK, AND STRUCTURE. INSTALL FIRESTOP MATERIALS IN ALL GAPS PRIOR TO SEALANT APPLICATION. INSTALL SEALER ACCORDING TO MANUFACTURER'S WRITTEN INSTRUCTIONS.

25. THE CONTRACTOR /BUILDER SHALL BE RESPONSIBLE TO REMOVE OR DISBURSE ANY EXCESS MATERIAL FROM PROJECT SITE.

# **ABBREVIATIONS:**

UNLESS NOTED OTHERWISE U.N.O. ABV. SIM. SIMILAR CAB. **CABINET** R&S ROD AND SHELVES WDW. **WINDOW** CLG. CEILING CASED OPENING C.O. **TEMPERED** GYPSUM CONC. CONCRETE TYP. **TYPICAL** O.C. **ON CENTER CENTER LINE** MECH. **MECHANICAL** FURN. **FURNACE** WATER HEATER SIMILAR NTS. NOT TO SCALE **HEIGHT RCP** REFLECTED CEILING PLAN HJS HEAD, JAMB, AND SILL **EQUAL** WOOD SCH. SCHEDULE(D) **EGRESS TRANS TRANSOM** MTL. METAL CMU **CONCRETE MASONRY UNIT** EXIST. **EXISTING** 

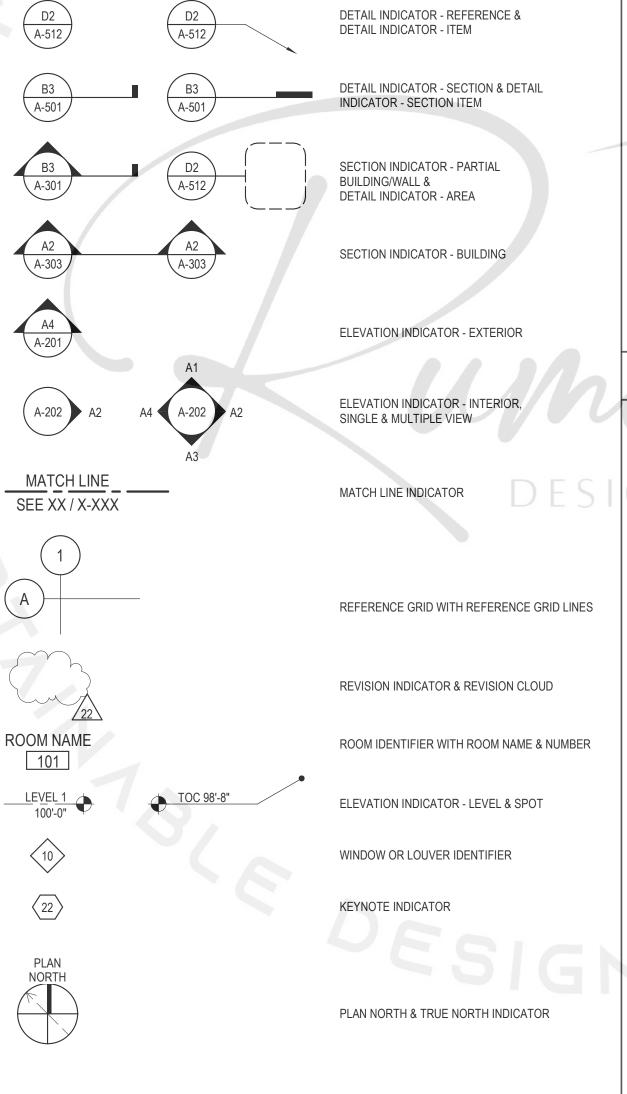

# NEW WOOD FRAME 2- STORY SINGLE FAMILY RESIDENCE PROJECT CONTACT INFO: SCOPE OF WORK: **DESIGNER:**

BUILDER/CONTRACTOR

**BUILDING DATA** 

**PROJECT LOCATION LOCATION MAP VICINITY MAP** 

> INTERNATIONAL BUILDING CODE INTERNATIONAL RESIDENTIAL CODE INTERNATIONAL FIRE CODE INTERNATIONAL PLUMBING CODE INTERNATIONAL MECHANICAL CODE INTERNATIONAL FUEL GAS CODE NATIONAL ELECTRICAL CODE INTERNATIONAL ENERGY CONSERVATION

**APPLICABLE CODES** 

# **SHEET INDEX:**

SHEET NAME	SHEET NUMBER
COVER SHEET	A-1.0
FIRST FLOOR PLAN	A-2.0
SECOND FLOOR PLAN	A-3.0
FRONT & REAR ELEVATION	A-4.0
LEFT & RIGHT ELEVATION	A-5.0
ROOF PLAN	A-6.0
BUILDING SECTION-1&2	A-7.0
FIRST FLOOR ELECTRICAL PLAN	E-1.0
SECOND FLOOR ELECTRICAL PLAN	E-2.0
FIRST FLOOR HVAC PLAN	M-1.0
SECOND FLOOR HVAC PLAN	M-2.0
FIRST FLOOR PLUMBING	P-1.0
SECOND FLOOR PLUMBING PLAN	P-2.0
FOUNDATION PLAN	S-1.0
TYPICAL WALL SECTION	S-2.0



no liability for any structure constructed from this plan. It is the responsibility of the contractor to perform the ) Contractor must verify ALL Dimensions on sheets and 2) Contractor must verify compliance with ALL Local

aspect should incorporate actual site conditions shown

REVISION SCHEDULE: DATE NO. DESCRIPTION PROJECT NUMBER

PROJECT OWNERS:

CONTRACTOR:

COVER SHEET


DRAWN BY: CHECKED BY

**Project Status** 

DOCUMENT ISSUED 5/29/2025 10:06:11 PM

ARCH D 24" X 36"

SCALE: 1/4" = 1'-0" SHEET NO.

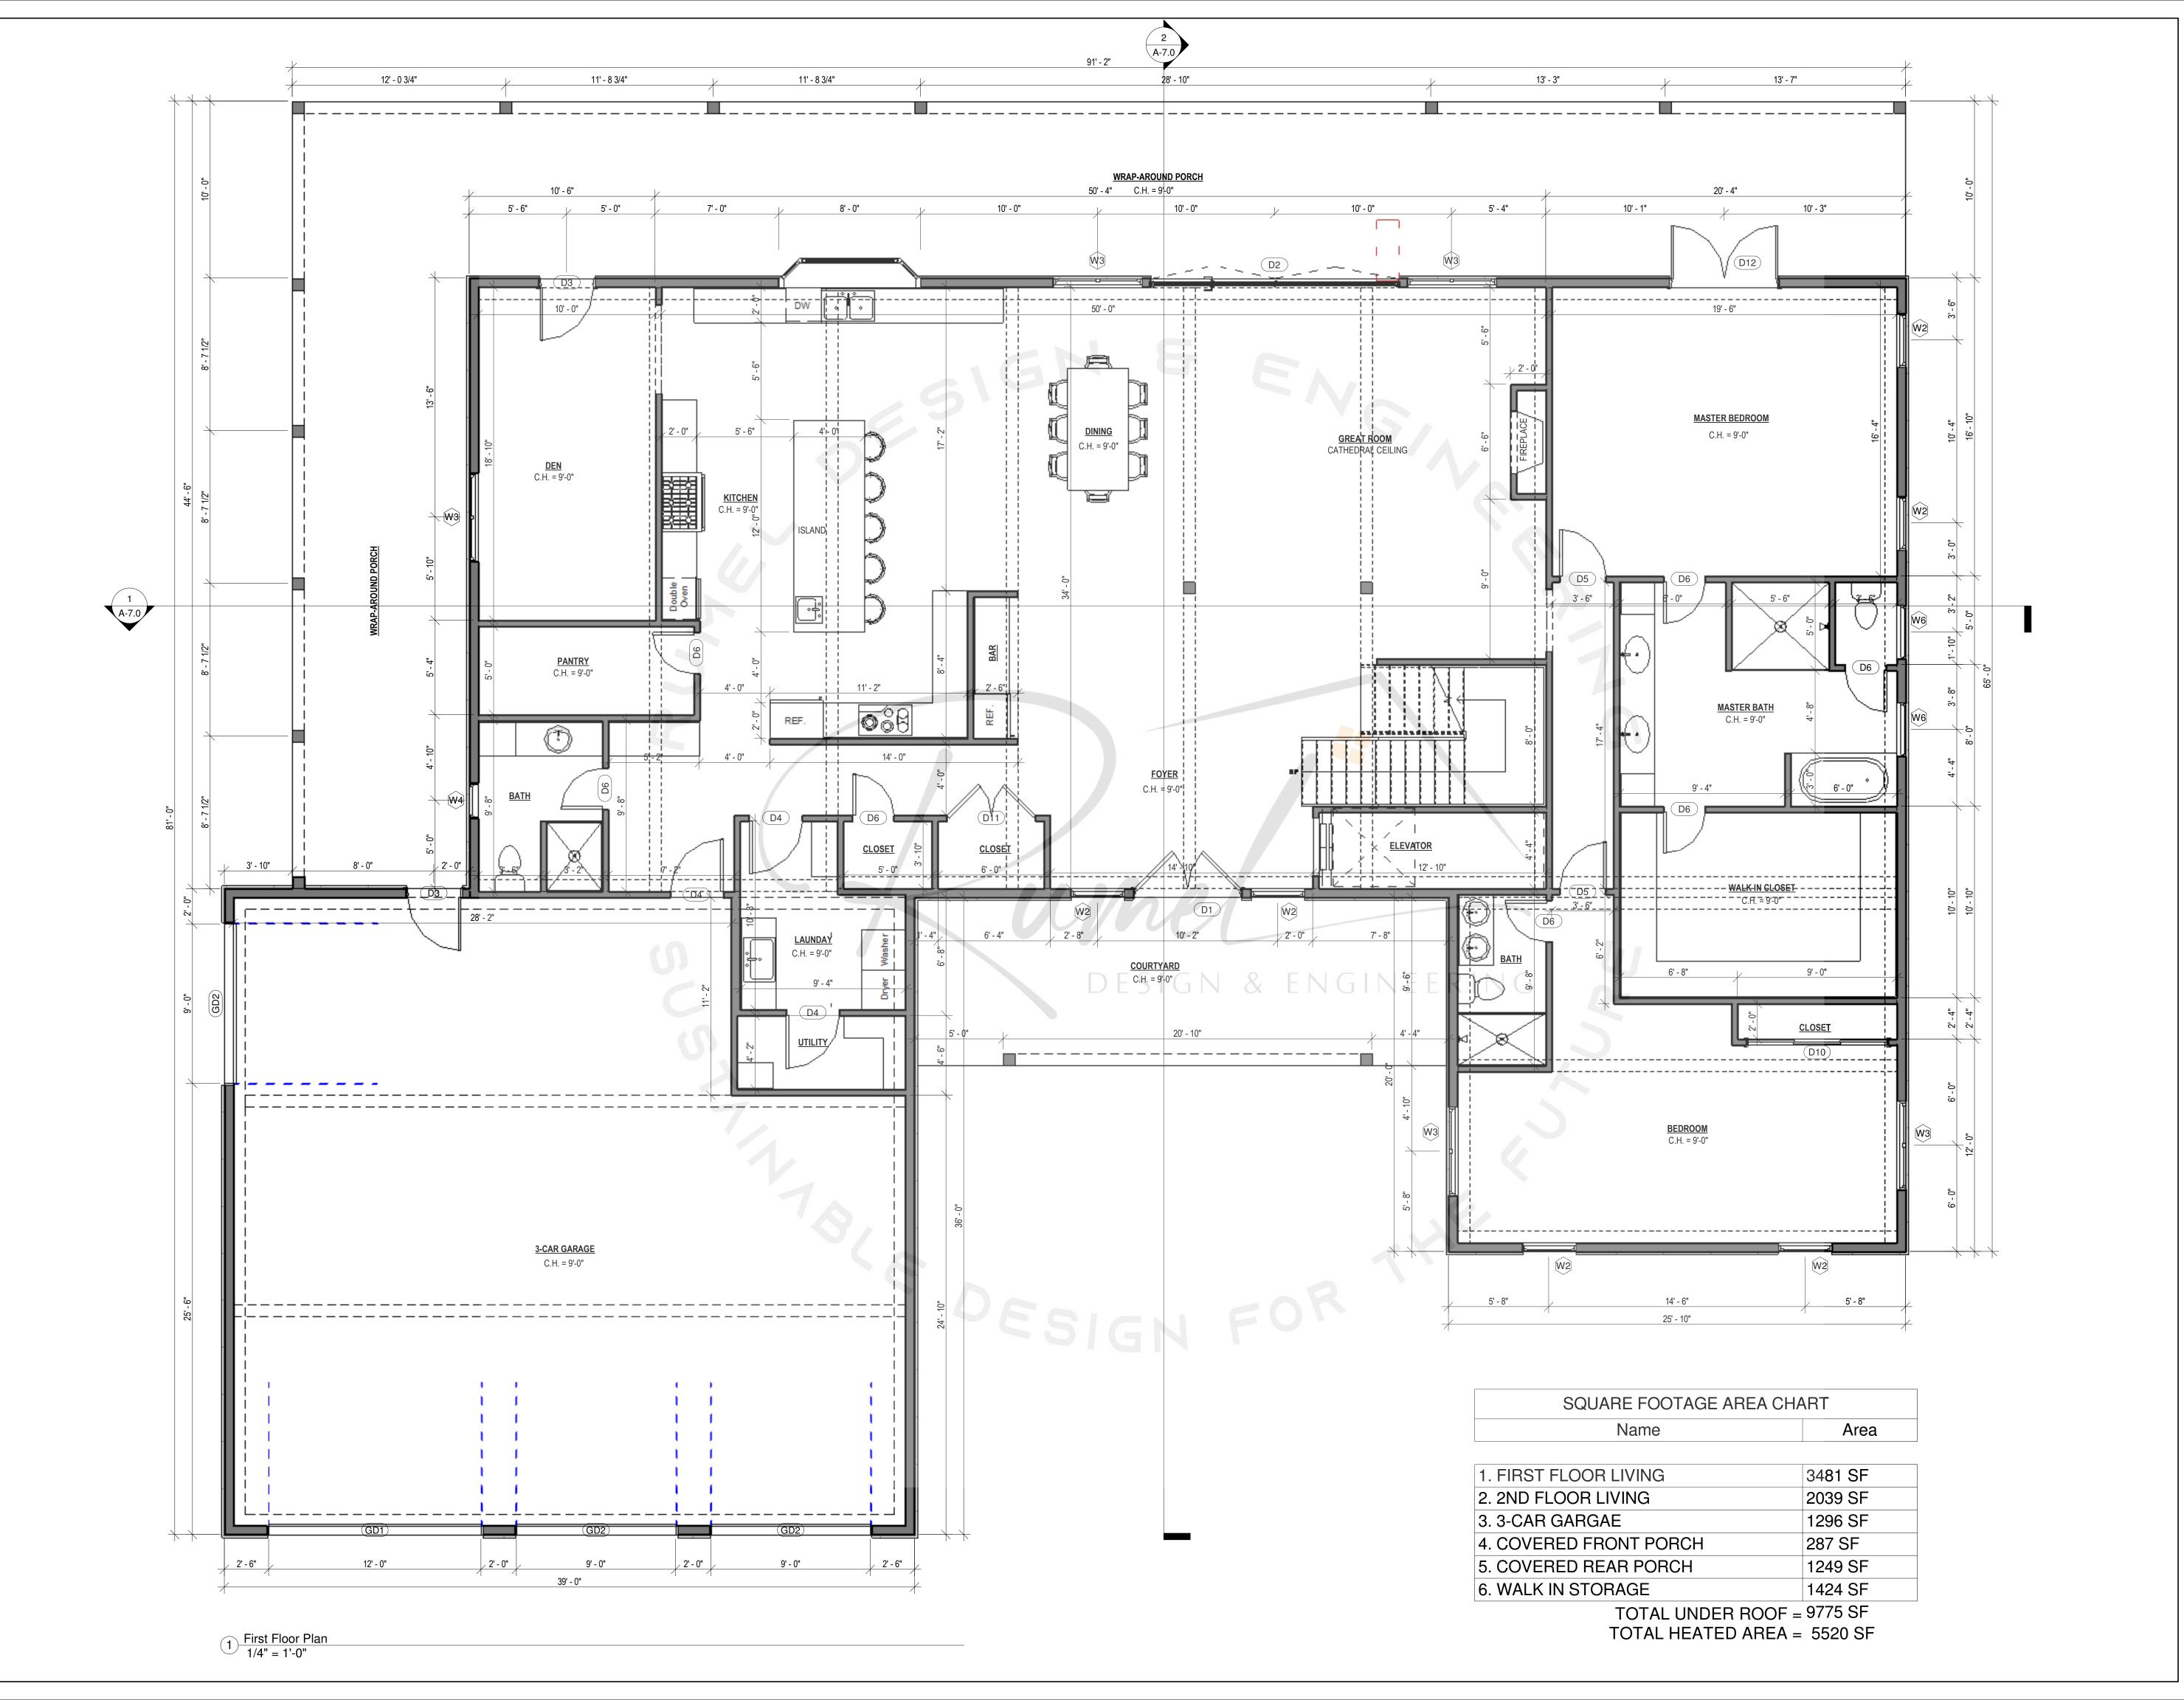



© COPYRIGHT BY RUMEL DESIGN \$ ENGINEERING ALL RIGHTS RESERVED.

PLEASE NOTE: Rumel design & Engineering. assumes no liability for any structure constructed from this plan. It is the responsibility of the contractor to perform the following before beginning construction:

1) Contractor must verify ALL Dimensions on sheets and in field prior to proceeding with construction. 2) Contractor must verify compliance with ALL Local Building Codes in the area the project is to be constructed.

3) Plans indicate locations only, building engineering aspect should incorporate actual site conditions shown on a Survey provided by Owners Consultant

REVISION SCHEDULE:

NO. DESCRIPTION

DATE

PROJECT NUMBER:

PROJECT OWNERS:

CONTRACTOR:

FIRST FLOOR PLAN

CHECKED BY

**Project Status** 

DOCUMENT ISSUED


ARCH D 24" X 36"

5/29/2025 10:06:12 PM

SCALE: 1/4" = 1'-0"

SHEET NO.



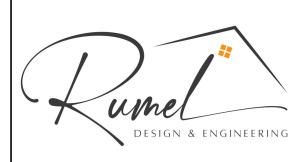

© COPYRIGHT BY RUMEL DESIGN \$ ENGINEERING ALL RIGHTS RESERVED.

PLEASE NOTE: Rumel design & Engineering. assumes no liability for any structure constructed from this plan. It is the responsibility of the contractor to perform the following before beginning construction:

1) Contractor must verify ALL Dimensions on sheets and in field prior to proceeding with construction. 2) Contractor must verify compliance with ALL Local Building Codes in the area the project is to be constructed.

Plans indicate locations only, building engineering aspect should incorporate actual site conditions shown on a Survey provided by Owners Consultant

DATE

PROJECT NUMBER:

SHEET TITLE: SECOND FLOOR

CHECKED BY:


**Project Status** 

ARCH D 24" X 36"

DOCUMENT ISSUED

5/29/2025 10:06:13 PM

SHEET NO.

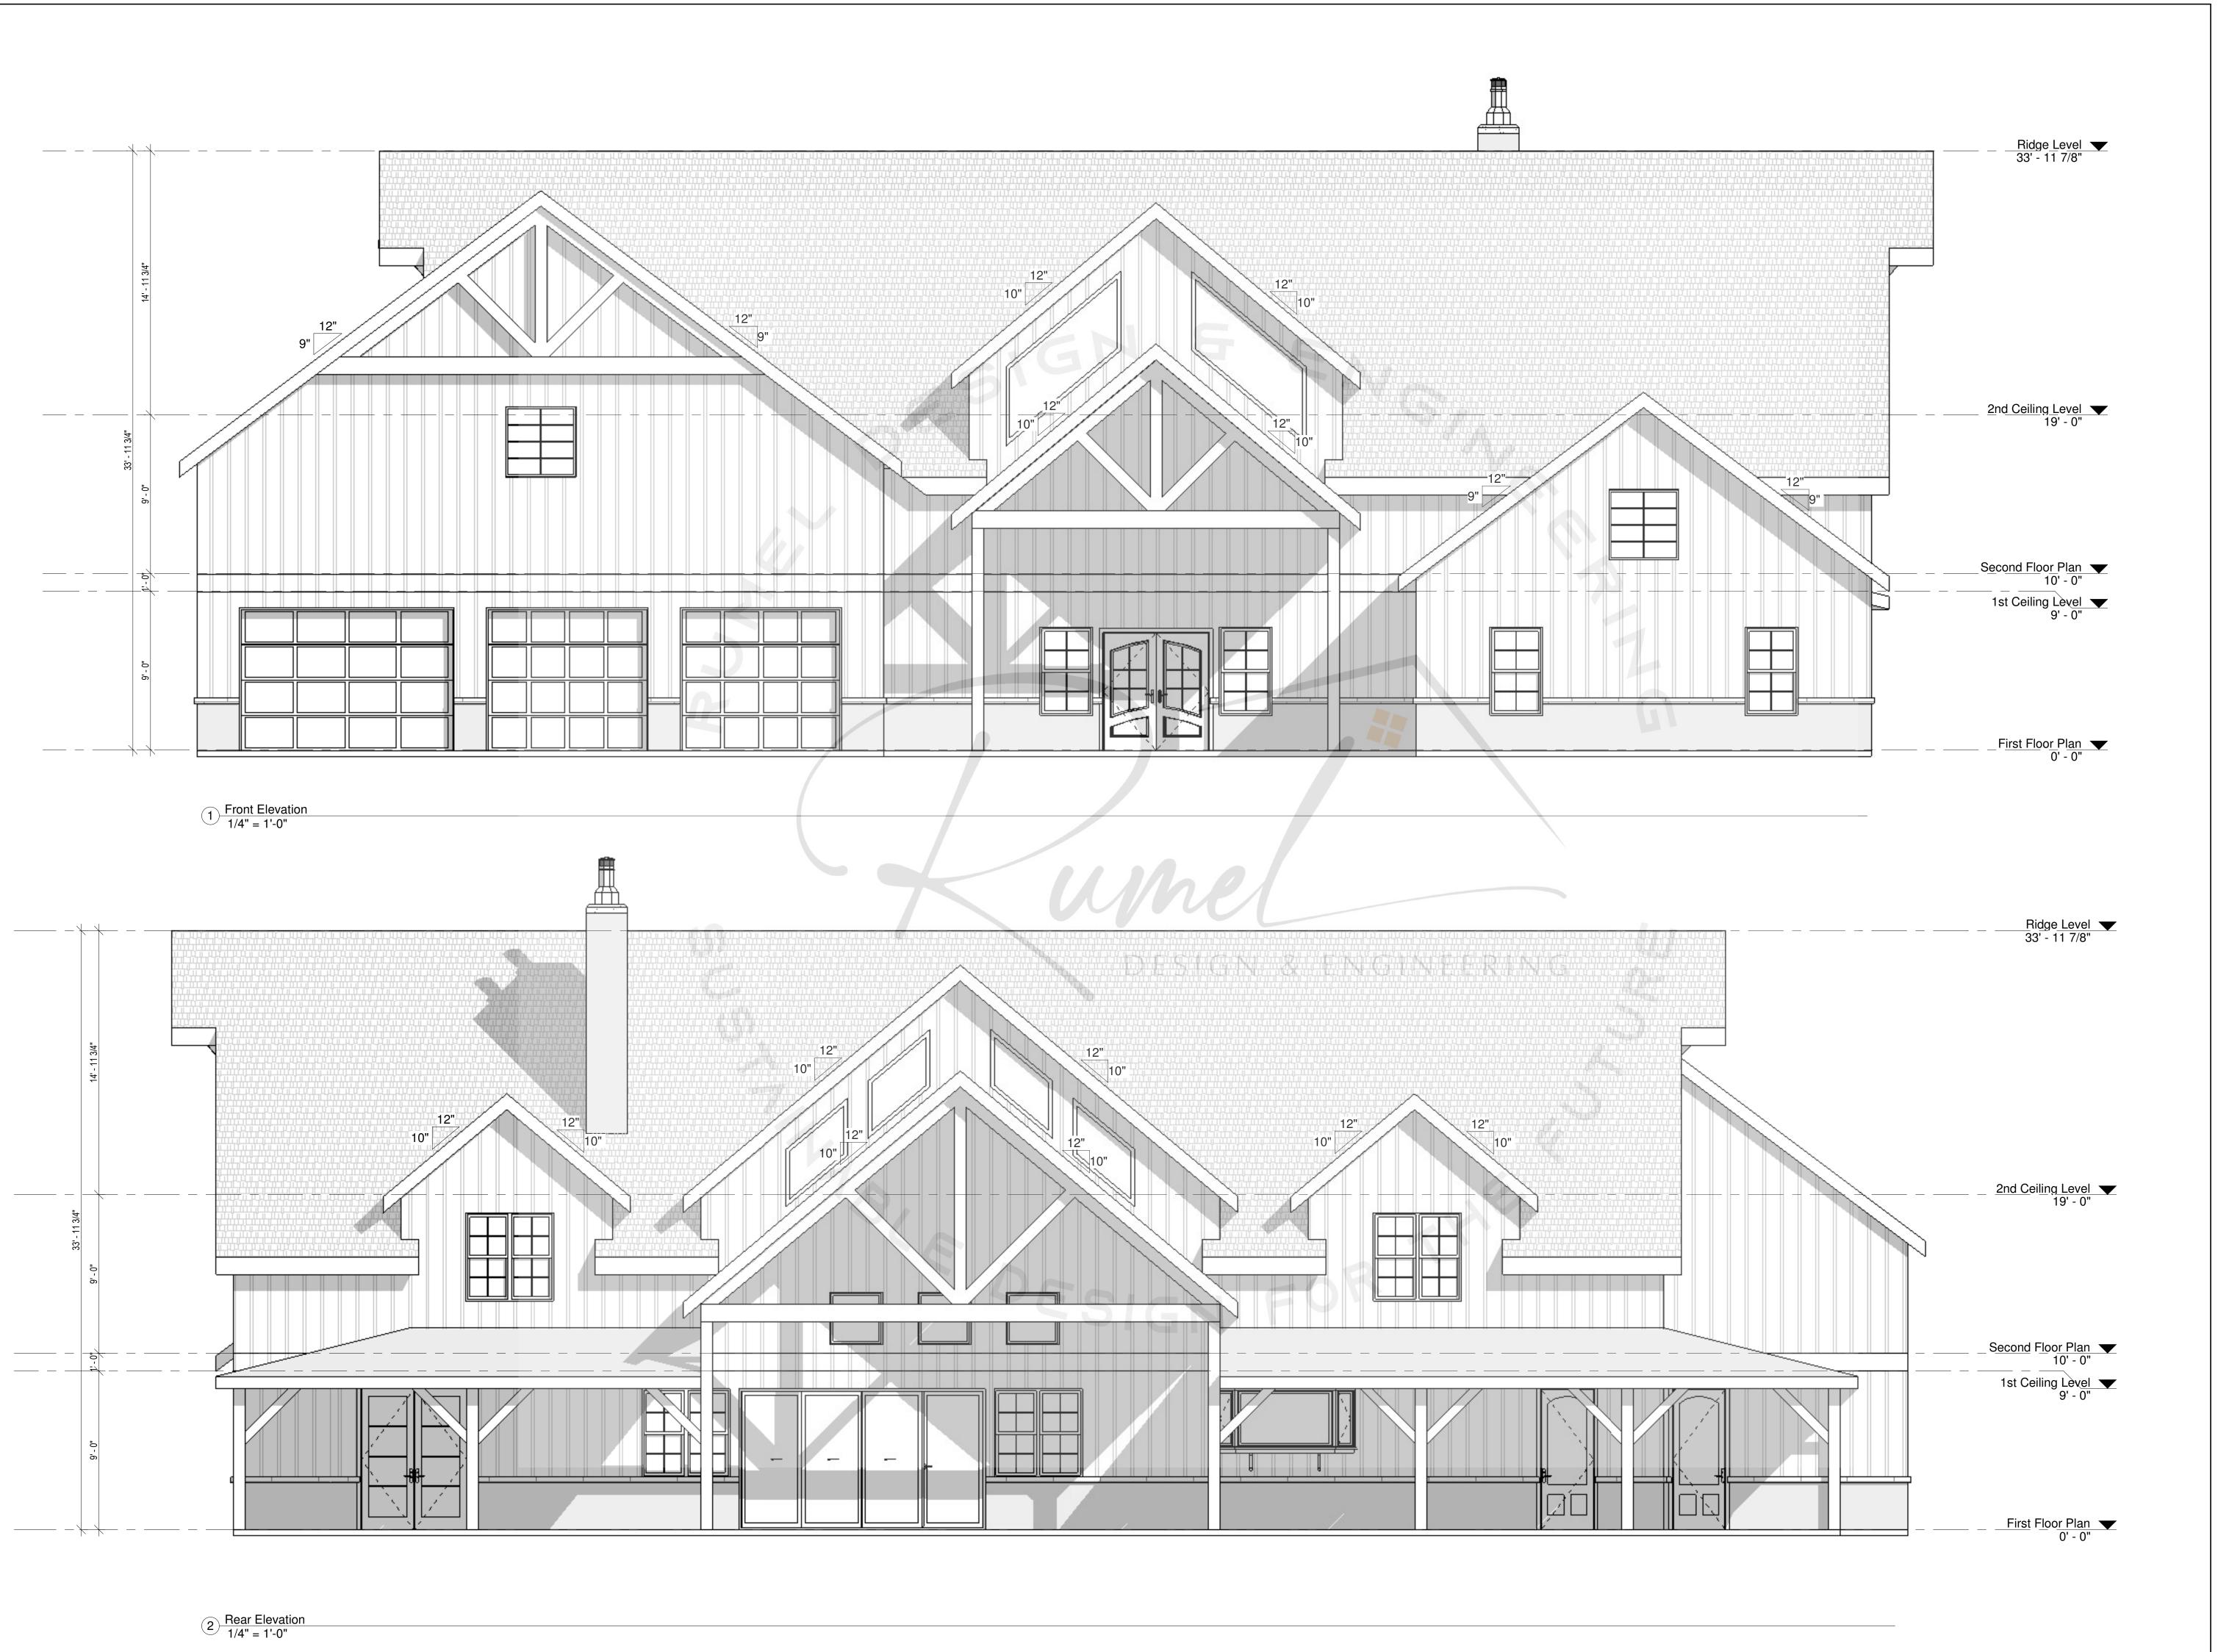



© COPYRIGHT BY RUMEL DESIGN \$ ENGINEERING ALL RIGHTS RESERVED.

PLEASE NOTE: Rumel design & Engineering. assumes no liability for any structure constructed from this plan. It is the responsibility of the contractor to perform the following before beginning construction:

1) Contractor must verify ALL Dimensions on sheets and in field prior to proceeding with construction.

2) Contractor must verify compliance with ALL Local Building Codes in the area the project is to be

Building Codes in the area the project is to be constructed.

3) Plans indicate locations only, building engineering aspect should incorporate actual site conditions shown on a Survey provided by Owners Consultant

REVISION SCHEDULE:

NO. DESCRIPTION

DATE

PROJECT NUMBER:

١

.

PROJECT OWNERS:

CONTRACTOR:

SHEET TITLE:
FRONT & REAR
ELEVATION

DRAWN BY:

CHECKED BY:

Project Status

DOCUMENT ISSUED


5/29/2025 10:06:14 PM

SCALE: 1/4" = 1'-0"

ARCH D 24" X 36"

SHEET NO.

A-4<sub>-</sub>0

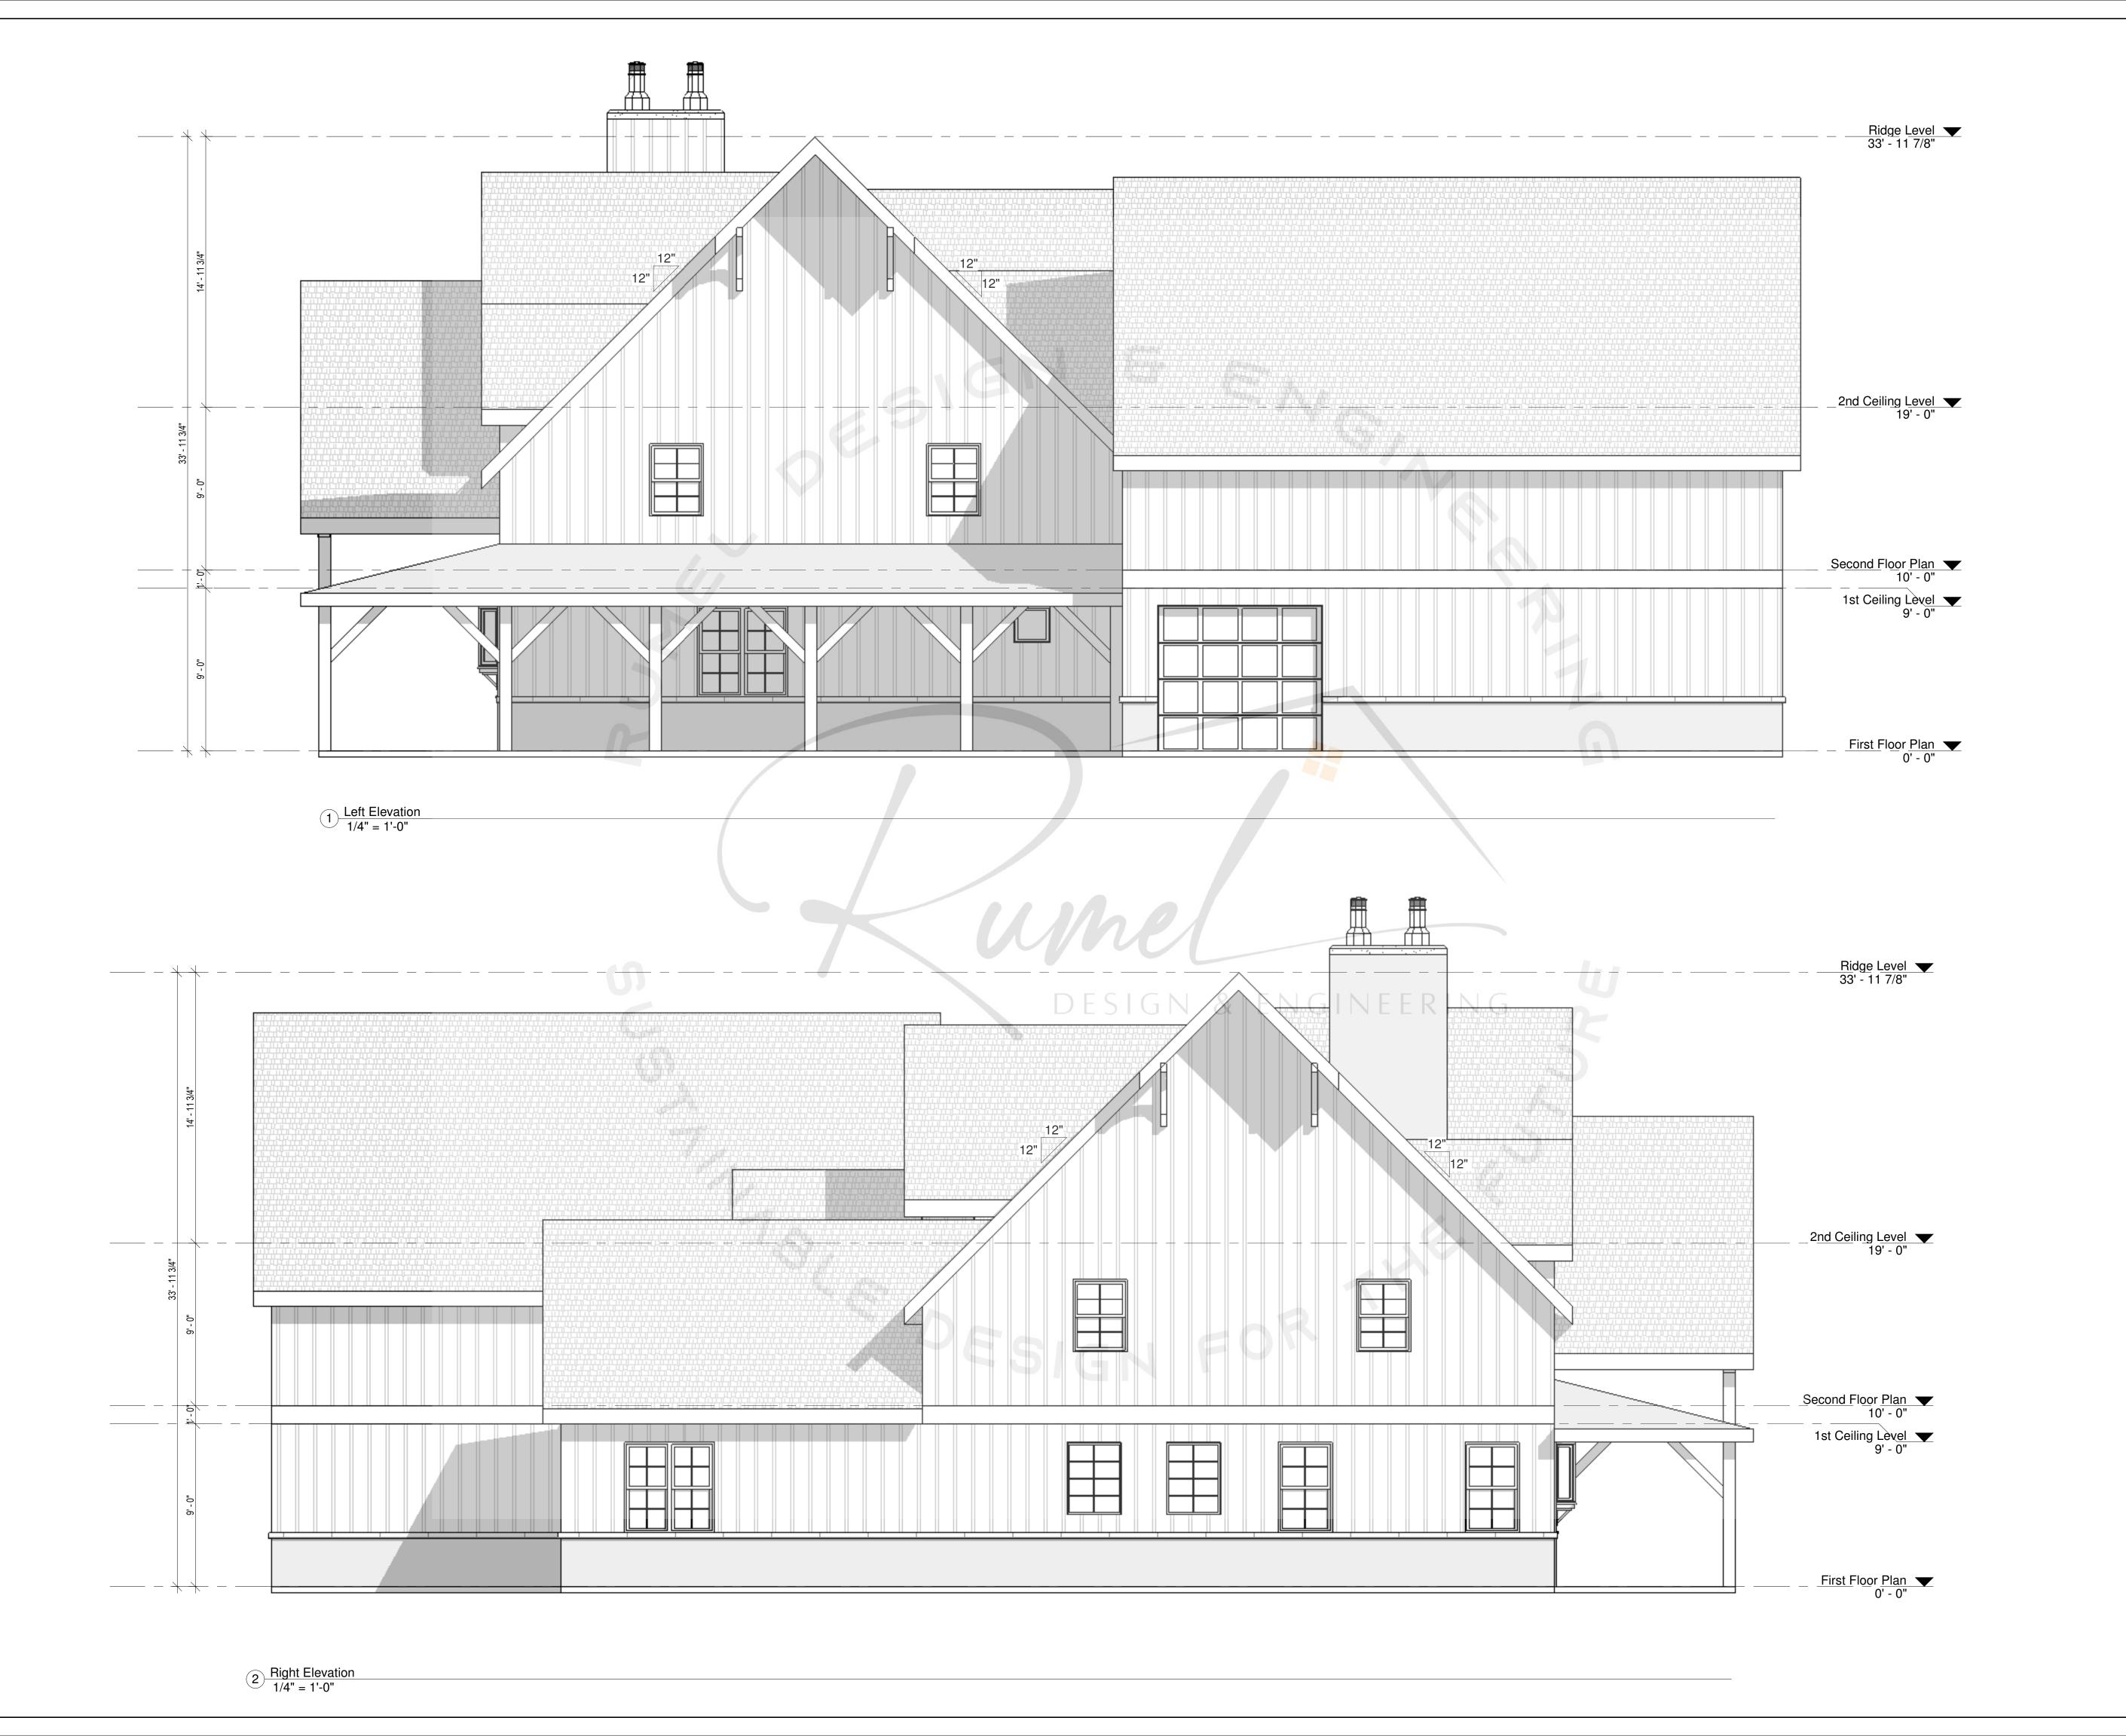



© COPYRIGHT BY RUMEL DESIGN & ENGINEERING ALL RIGHTS RESERVED.

PLEASE NOTE: Rumel design & Engineering. assumes no liability for any structure constructed from this plan. It is the responsibility of the contractor to perform the following before beginning construction:

1) Contractor must verify ALL Dimensions on sheets and in field prior to proceeding with construction.

2) Contractor must verify compliance with ALL Local Building Codes in the area the project is to be constructed.

Plans indicate locations only, building engineering aspect should incorporate actual site conditions shown on a Survey provided by Owners Consultant

REVISION SCHEDULE:

NO. DESCRIPTION

DATE

PROJECT NUMBER:

OJECT

PROJECT OWNERS:

CONTRACTOR:

SHEET TITLE:

LEFT & RIGHT

ELEVATION

DRAWN B

Project Status

CHECKED BY

DOCUMENT ISSUED


5/29/2025 10:06:15 PM

SCALE: 1/4" = 1'-0"

ARCH D 24" X 36"

SHEET NO.

A-5<sub>-</sub>0

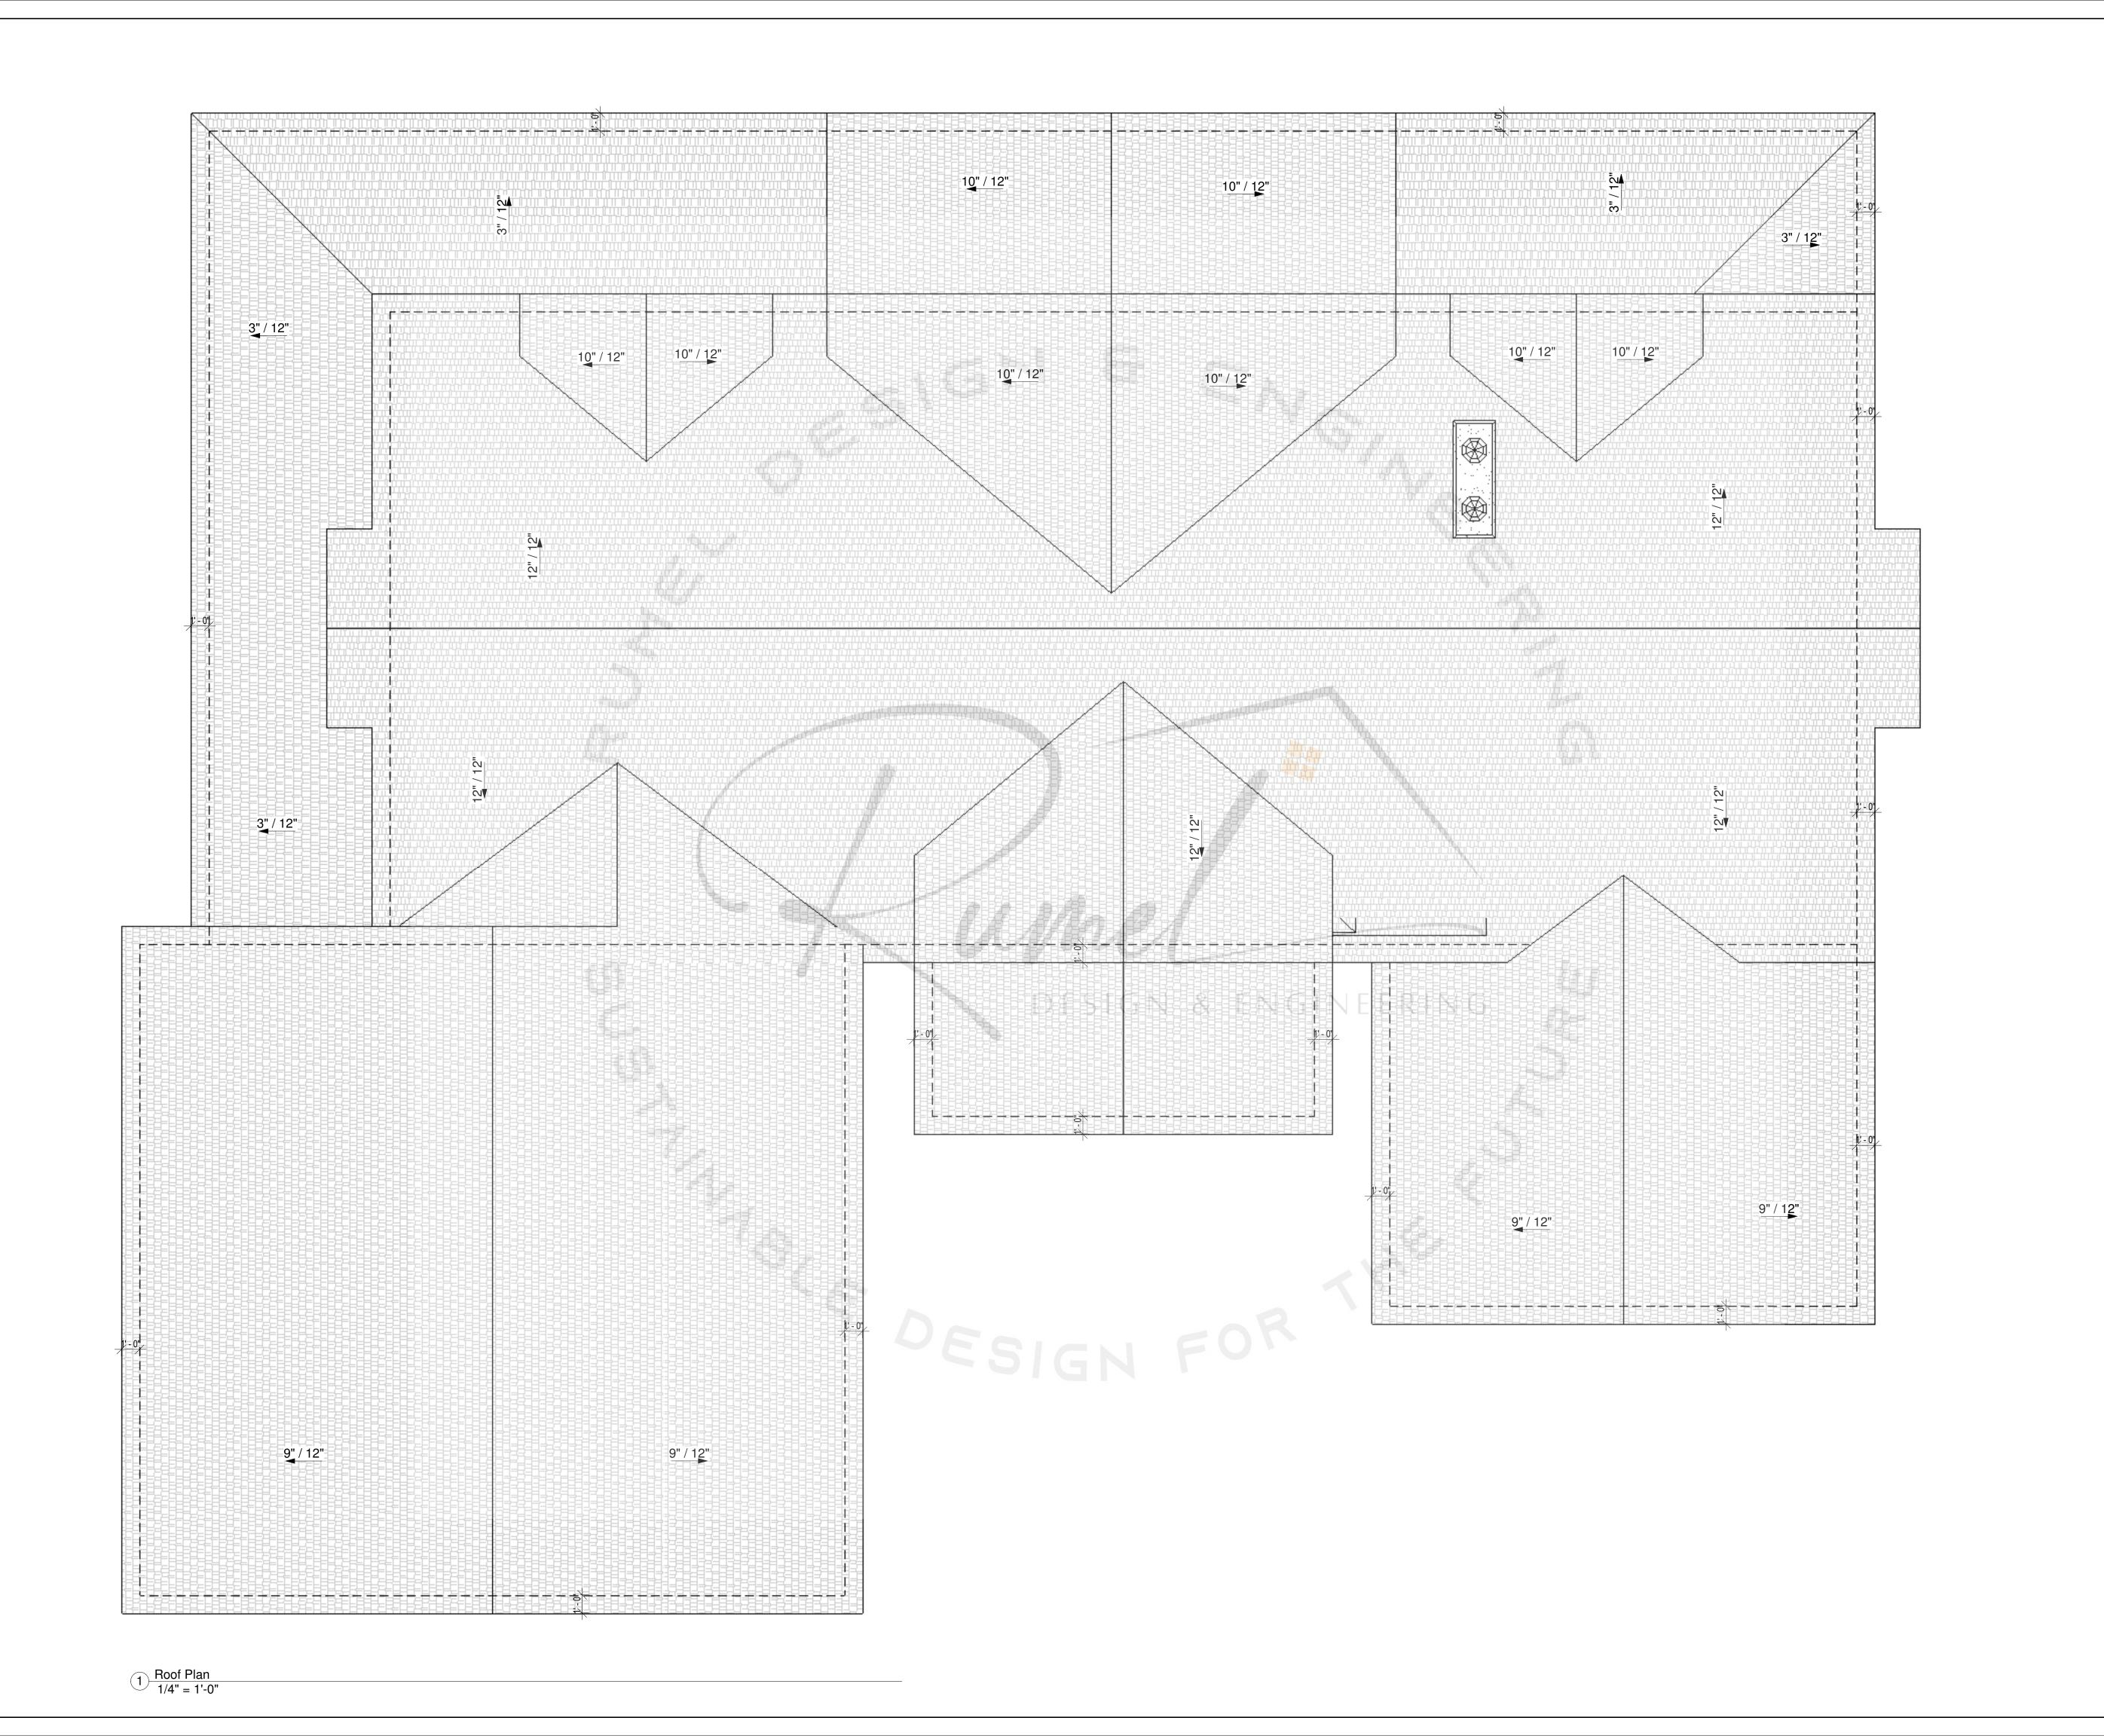



© COPYRIGHT BY RUMEL DESIGN & ENGINEERING ALL RIGHTS RESERVED.

PLEASE NOTE: Rumel design & Engineering. assumes no liability for any structure constructed from this plan. It is the responsibility of the contractor to perform the following before beginning construction:

1) Contractor must verify ALL Dimensions on sheets and in field prior to proceeding with construction.

2) Contractor must verify compliance with ALL Local Building Codes in the area the project is to be constructed.

3) Plans indicate locations only, building engineering aspect should incorporate actual site conditions shown on a Survey provided by Owners Consultant

REVISION SCHEDULE:

DATE

NO. DESCRIPTION

PROJECT NUMBER:

PROJECT OWNERS:

CONTRACTOR:

SHEET TITLE: ROOF PLAN


CHECKED BY

**Project Status** 

DOCUMENT ISSUED

5/29/2025 10:06:15 PM

SCALE: 1/4" = 1'-0"

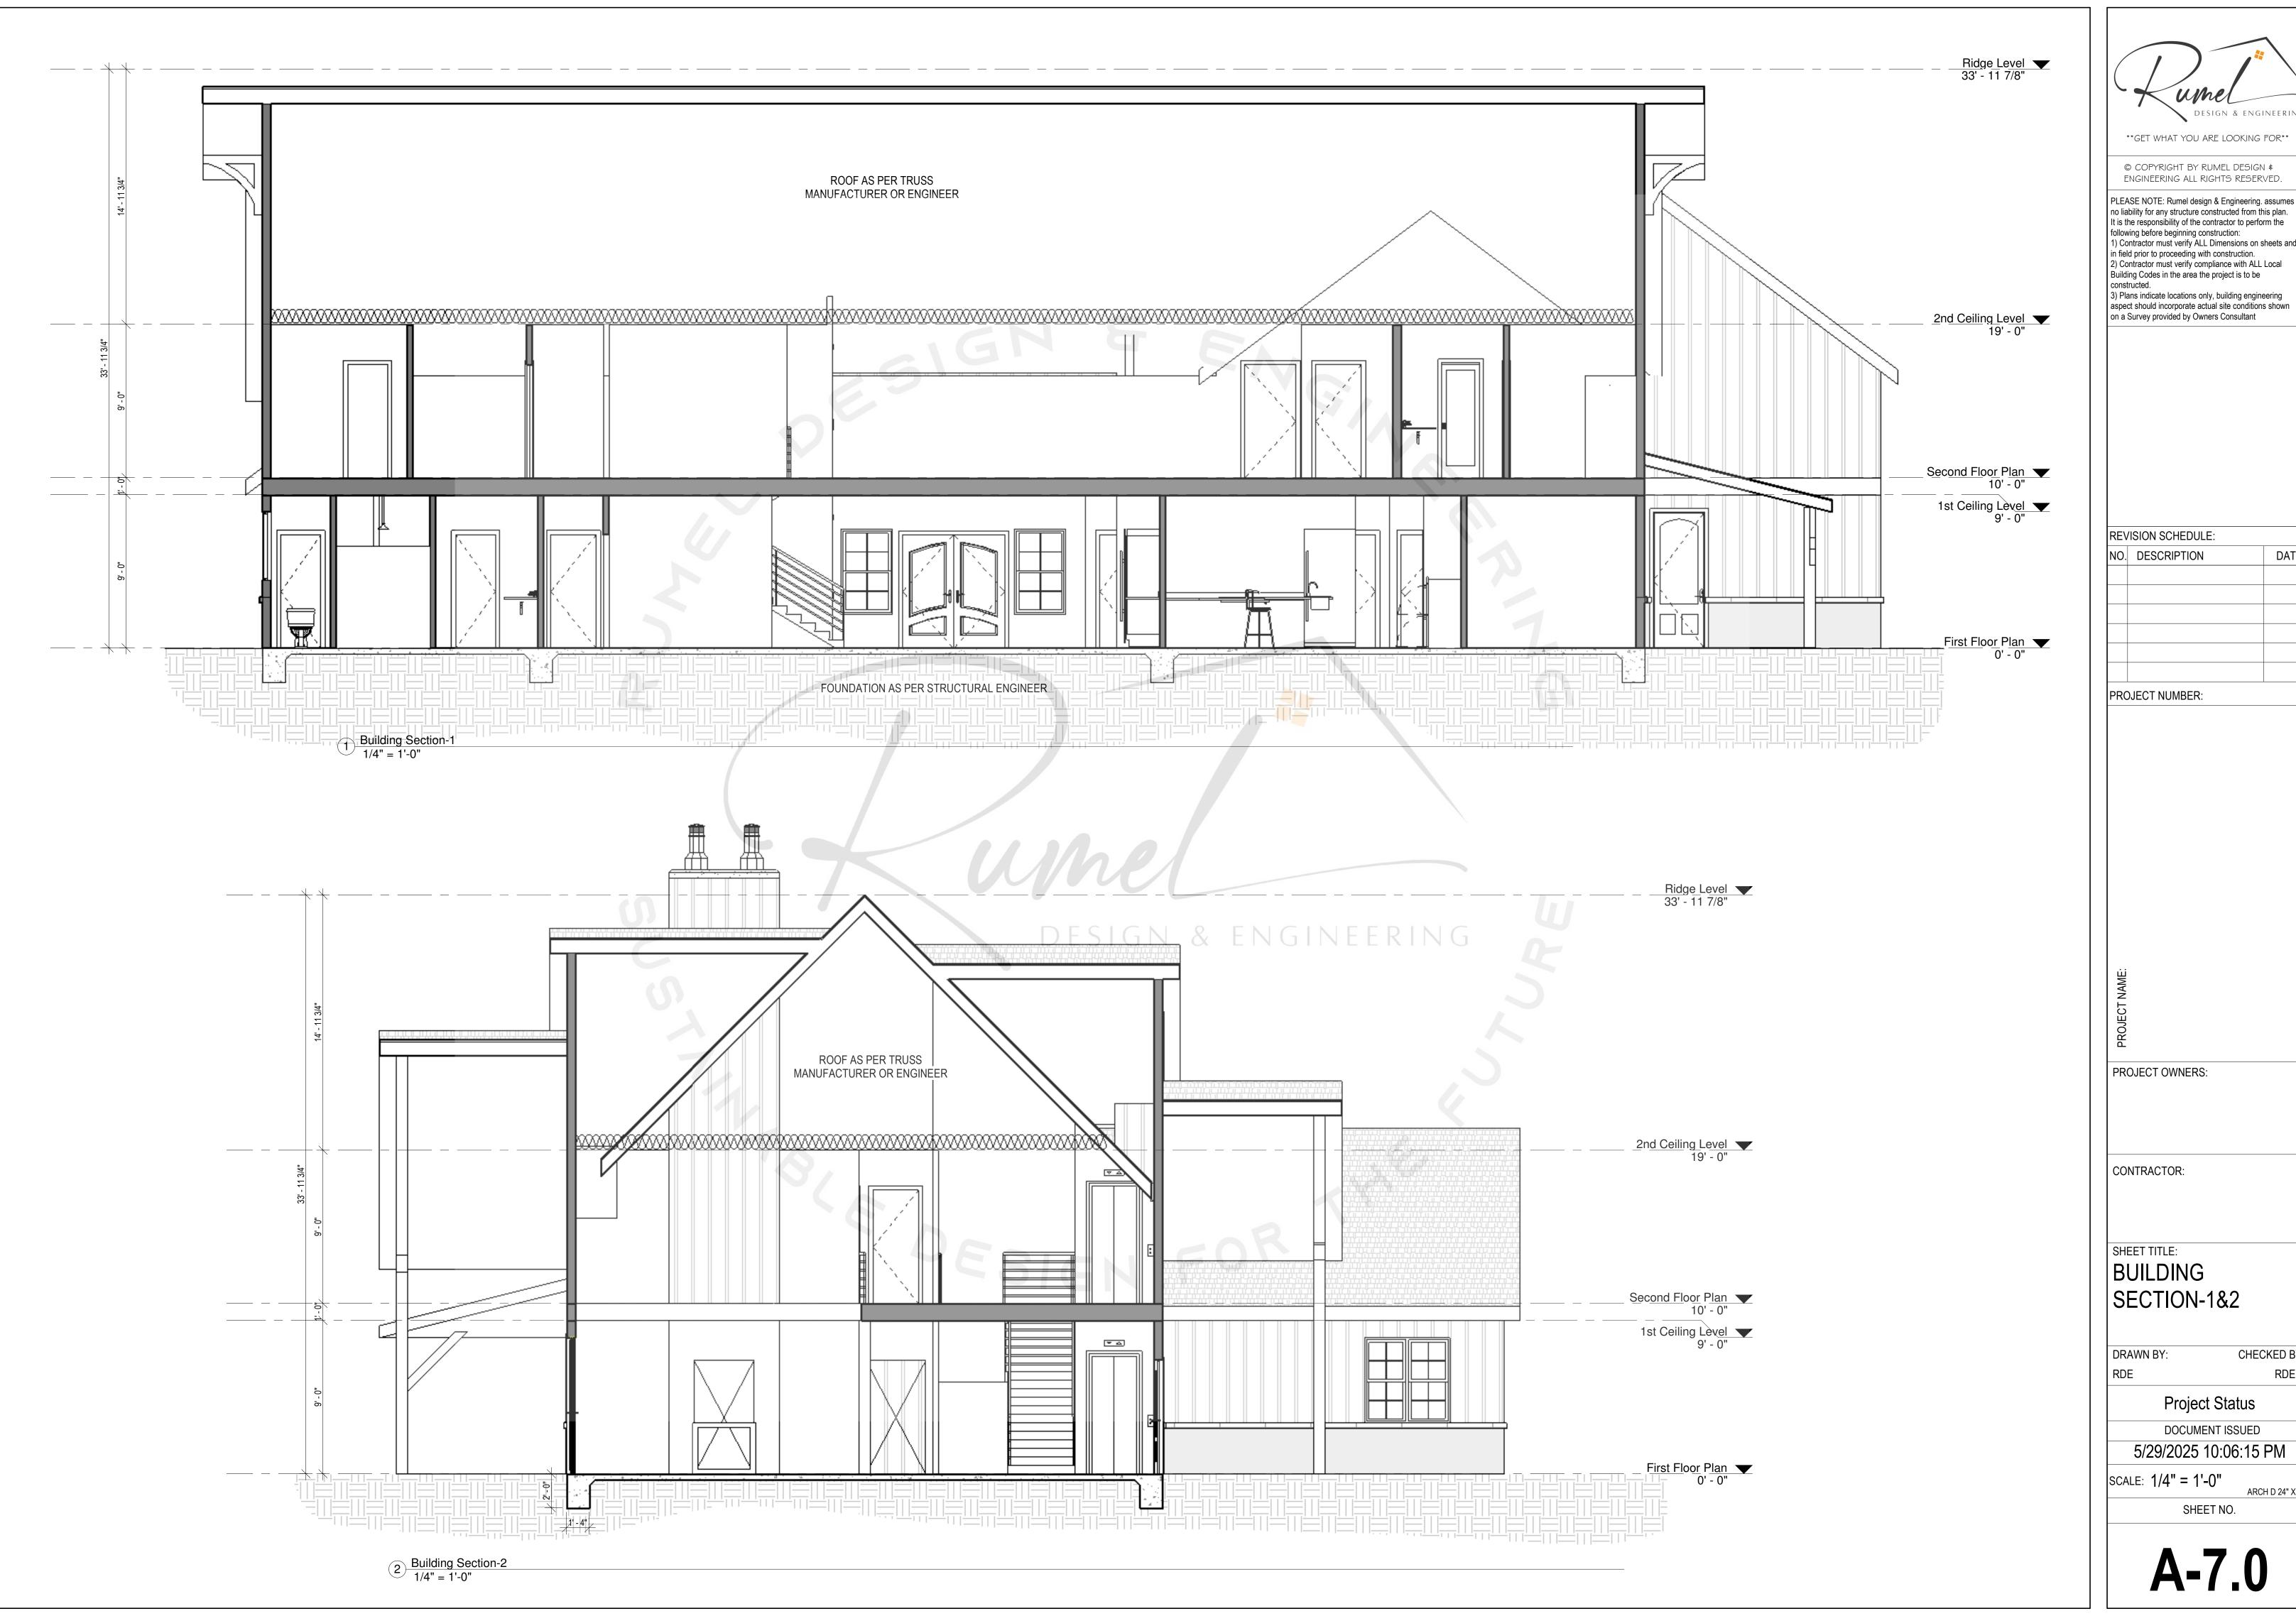

\*\*GET WHAT YOU ARE LOOKING FOR\*\*

© COPYRIGHT BY RUMEL DESIGN \$

PLEASE NOTE: Rumel design & Engineering. assumes no liability for any structure constructed from this plan. It is the responsibility of the contractor to perform the following before beginning construction:

1) Contractor must verify ALL Dimensions on sheets and in field prior to proceeding with construction.


2) Contractor must verify compliance with ALL Local Ruilding Codes in the area the project is to be


DATE

CHECKED BY:

DOCUMENT ISSUED

5/29/2025 10:06:15 PM

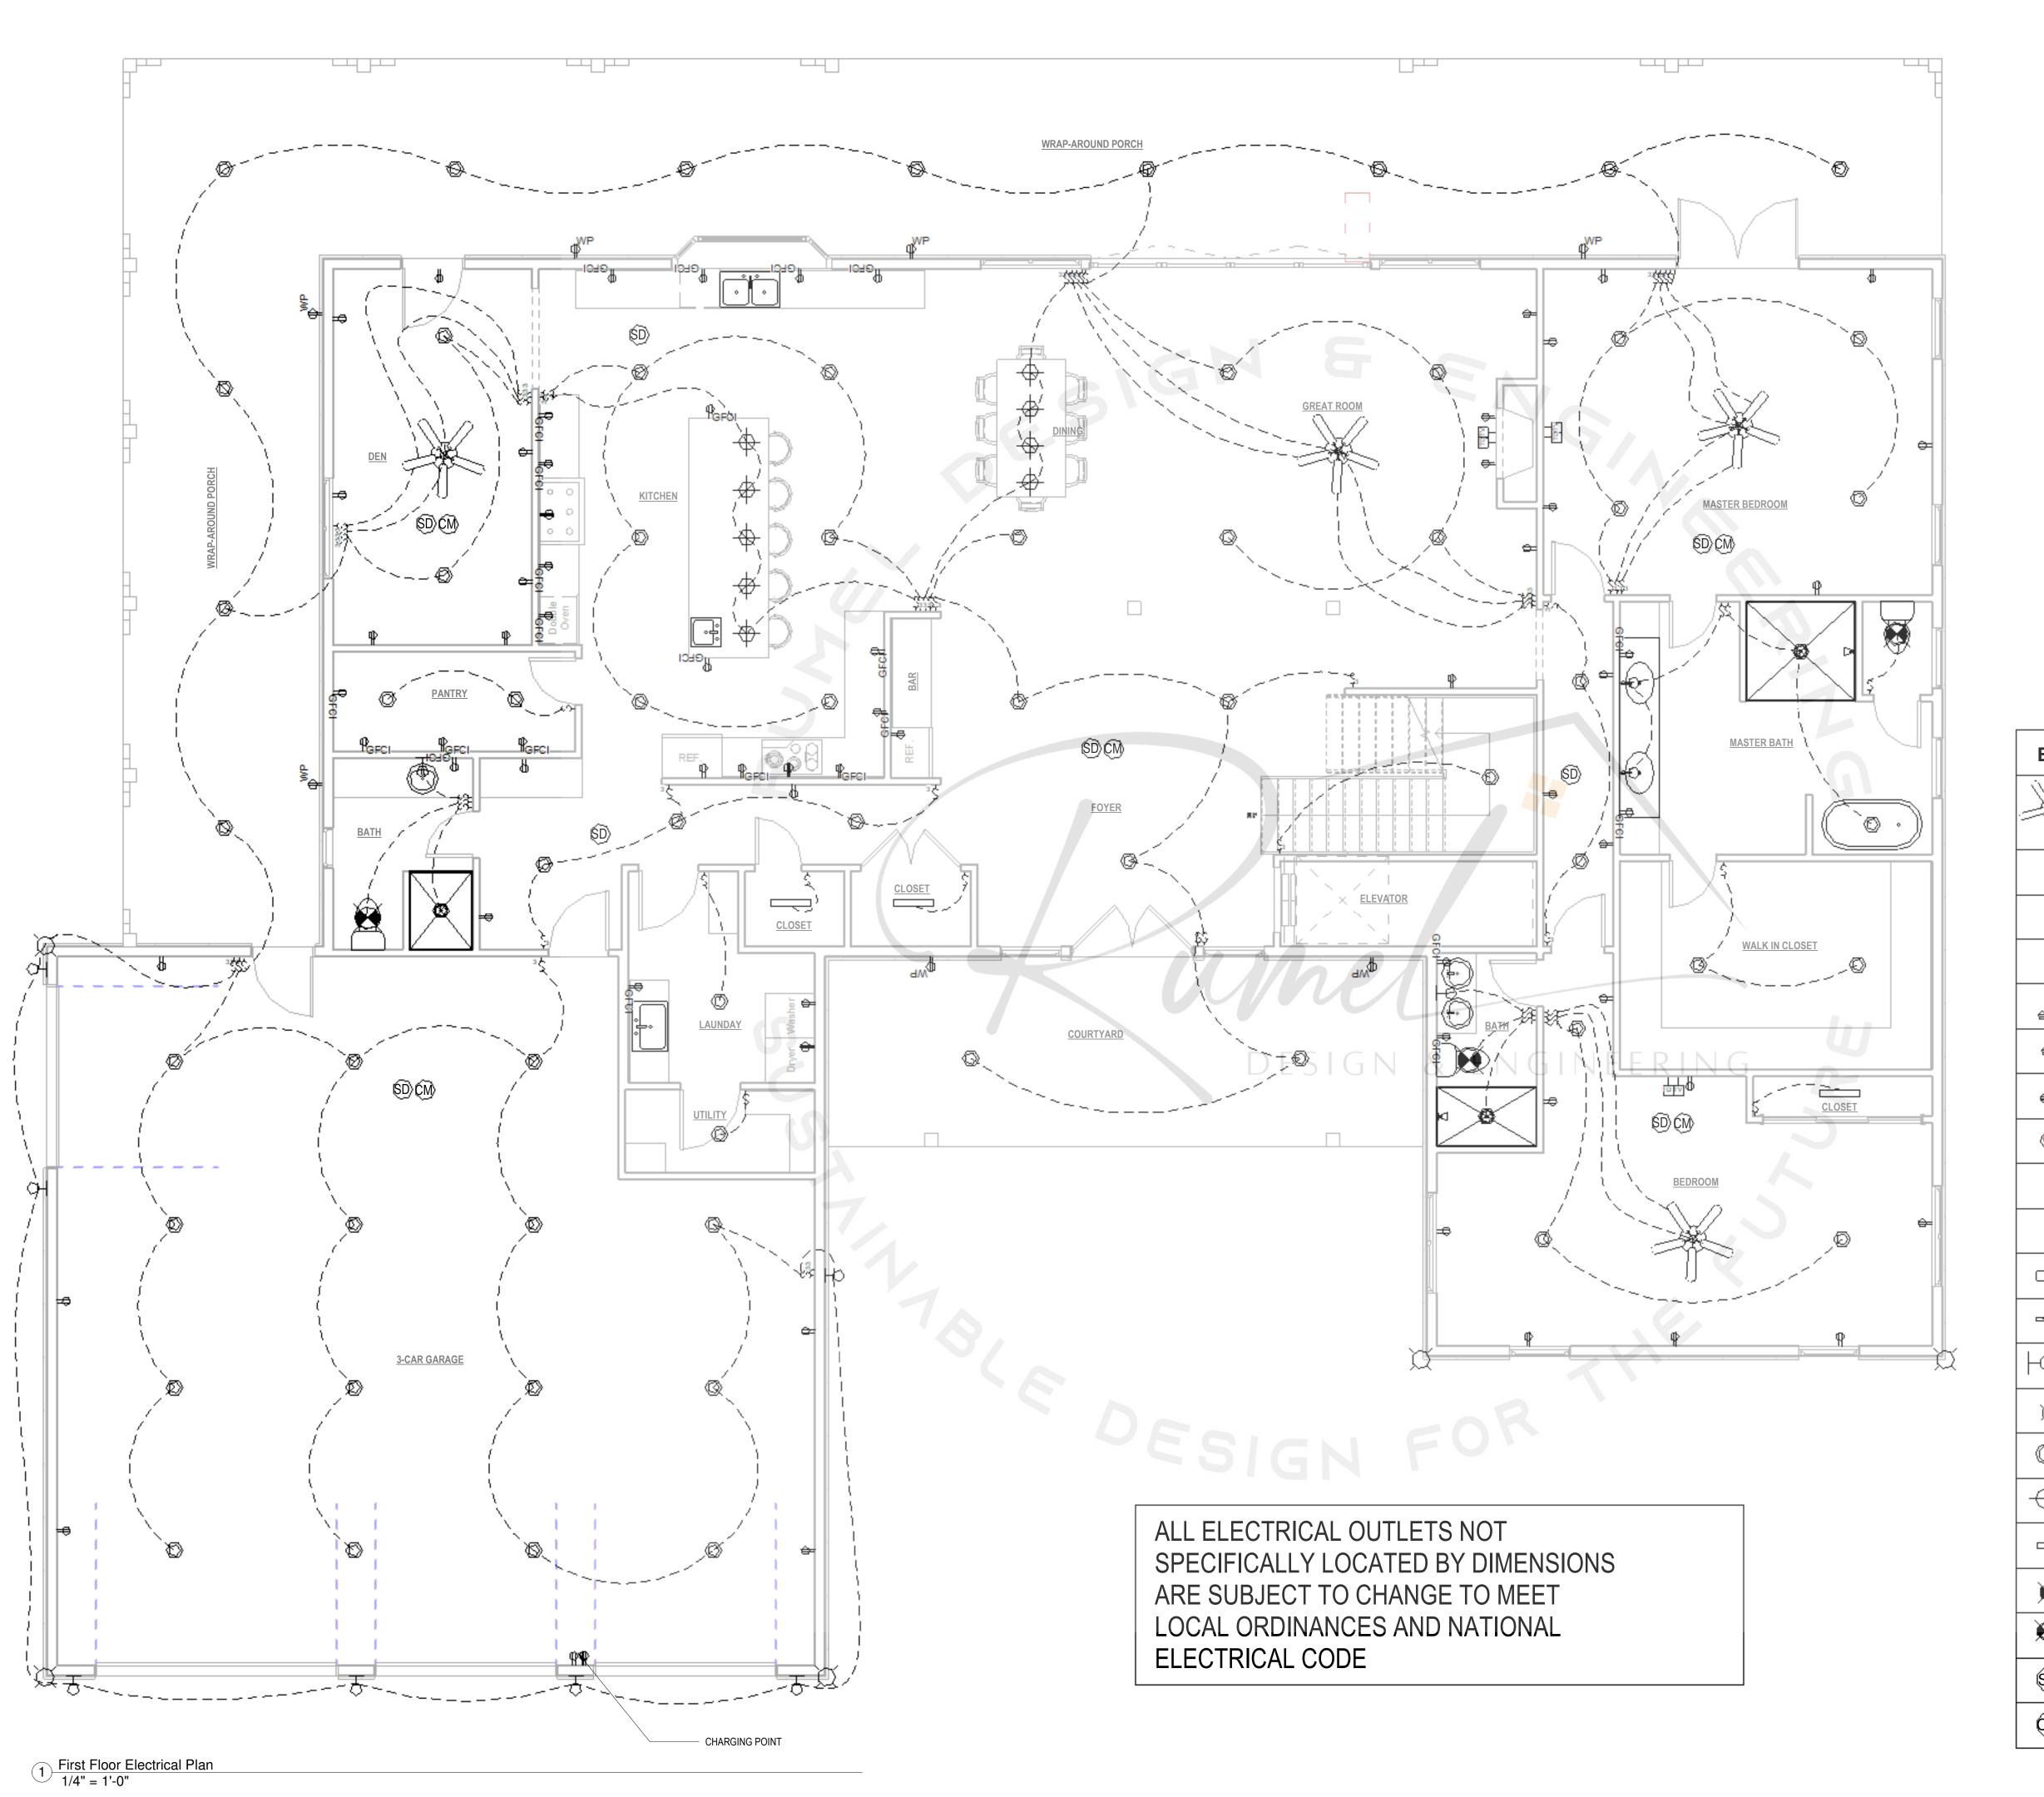

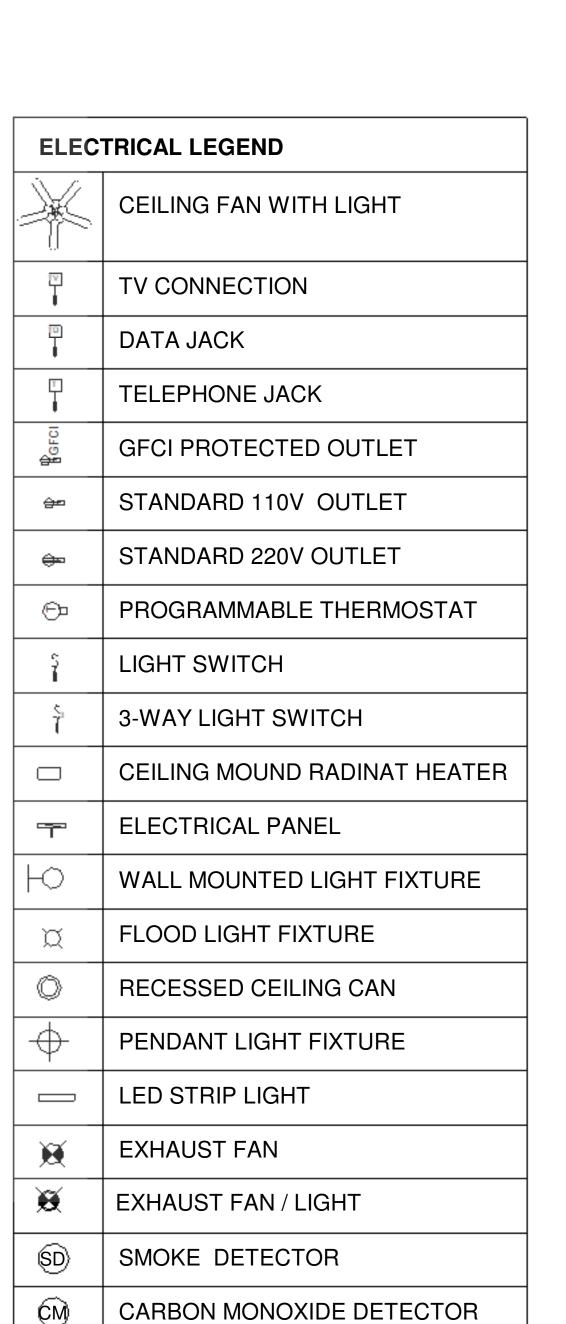

*	Uffe	SN & ENGIN	NEERING

© COPYRIGHT BY RUMEL DESIGN \$ ENGINEERING ALL RIGHTS RESERVED.

PLEASE NOTE: Rumel design & Engineering. assumes no liability for any structure constructed from this plan. It is the responsibility of the contractor to perform the following before beginning construction:

1) Contractor must verify ALL Dimensions on sheets and in field prior to proceeding with construction.

2) Contractor must verify compliance with ALL Local Building Codes in the area the project is to be

Plans indicate locations only, building engineering aspect should incorporate actual site conditions shown on a Survey provided by Owners Consultant

REVISION SCHEDULE:

NO. DESCRIPTION DATE

PROJECT NUMBER:

ピ PROJECT OWNERS:

CONTRACTOR:

SHEET TITLE:
FIRST FLOOR
ELECTRICAL PLAN

DRAWN BY: CHECKED BY:

Project Status

DOCUMENT ISSUED


5/29/2025 10:06:16 PM

SCALE: As indicated

SHEET NO.

E-1.0

ALL ELECTRICAL OUTLETS NOT SPECIFICALLY LOCATED BY DIMENSIONS ARE SUBJECT TO CHANGE TO MEET LOCAL ORDINANCES AND NATIONAL ELECTRICAL CODE

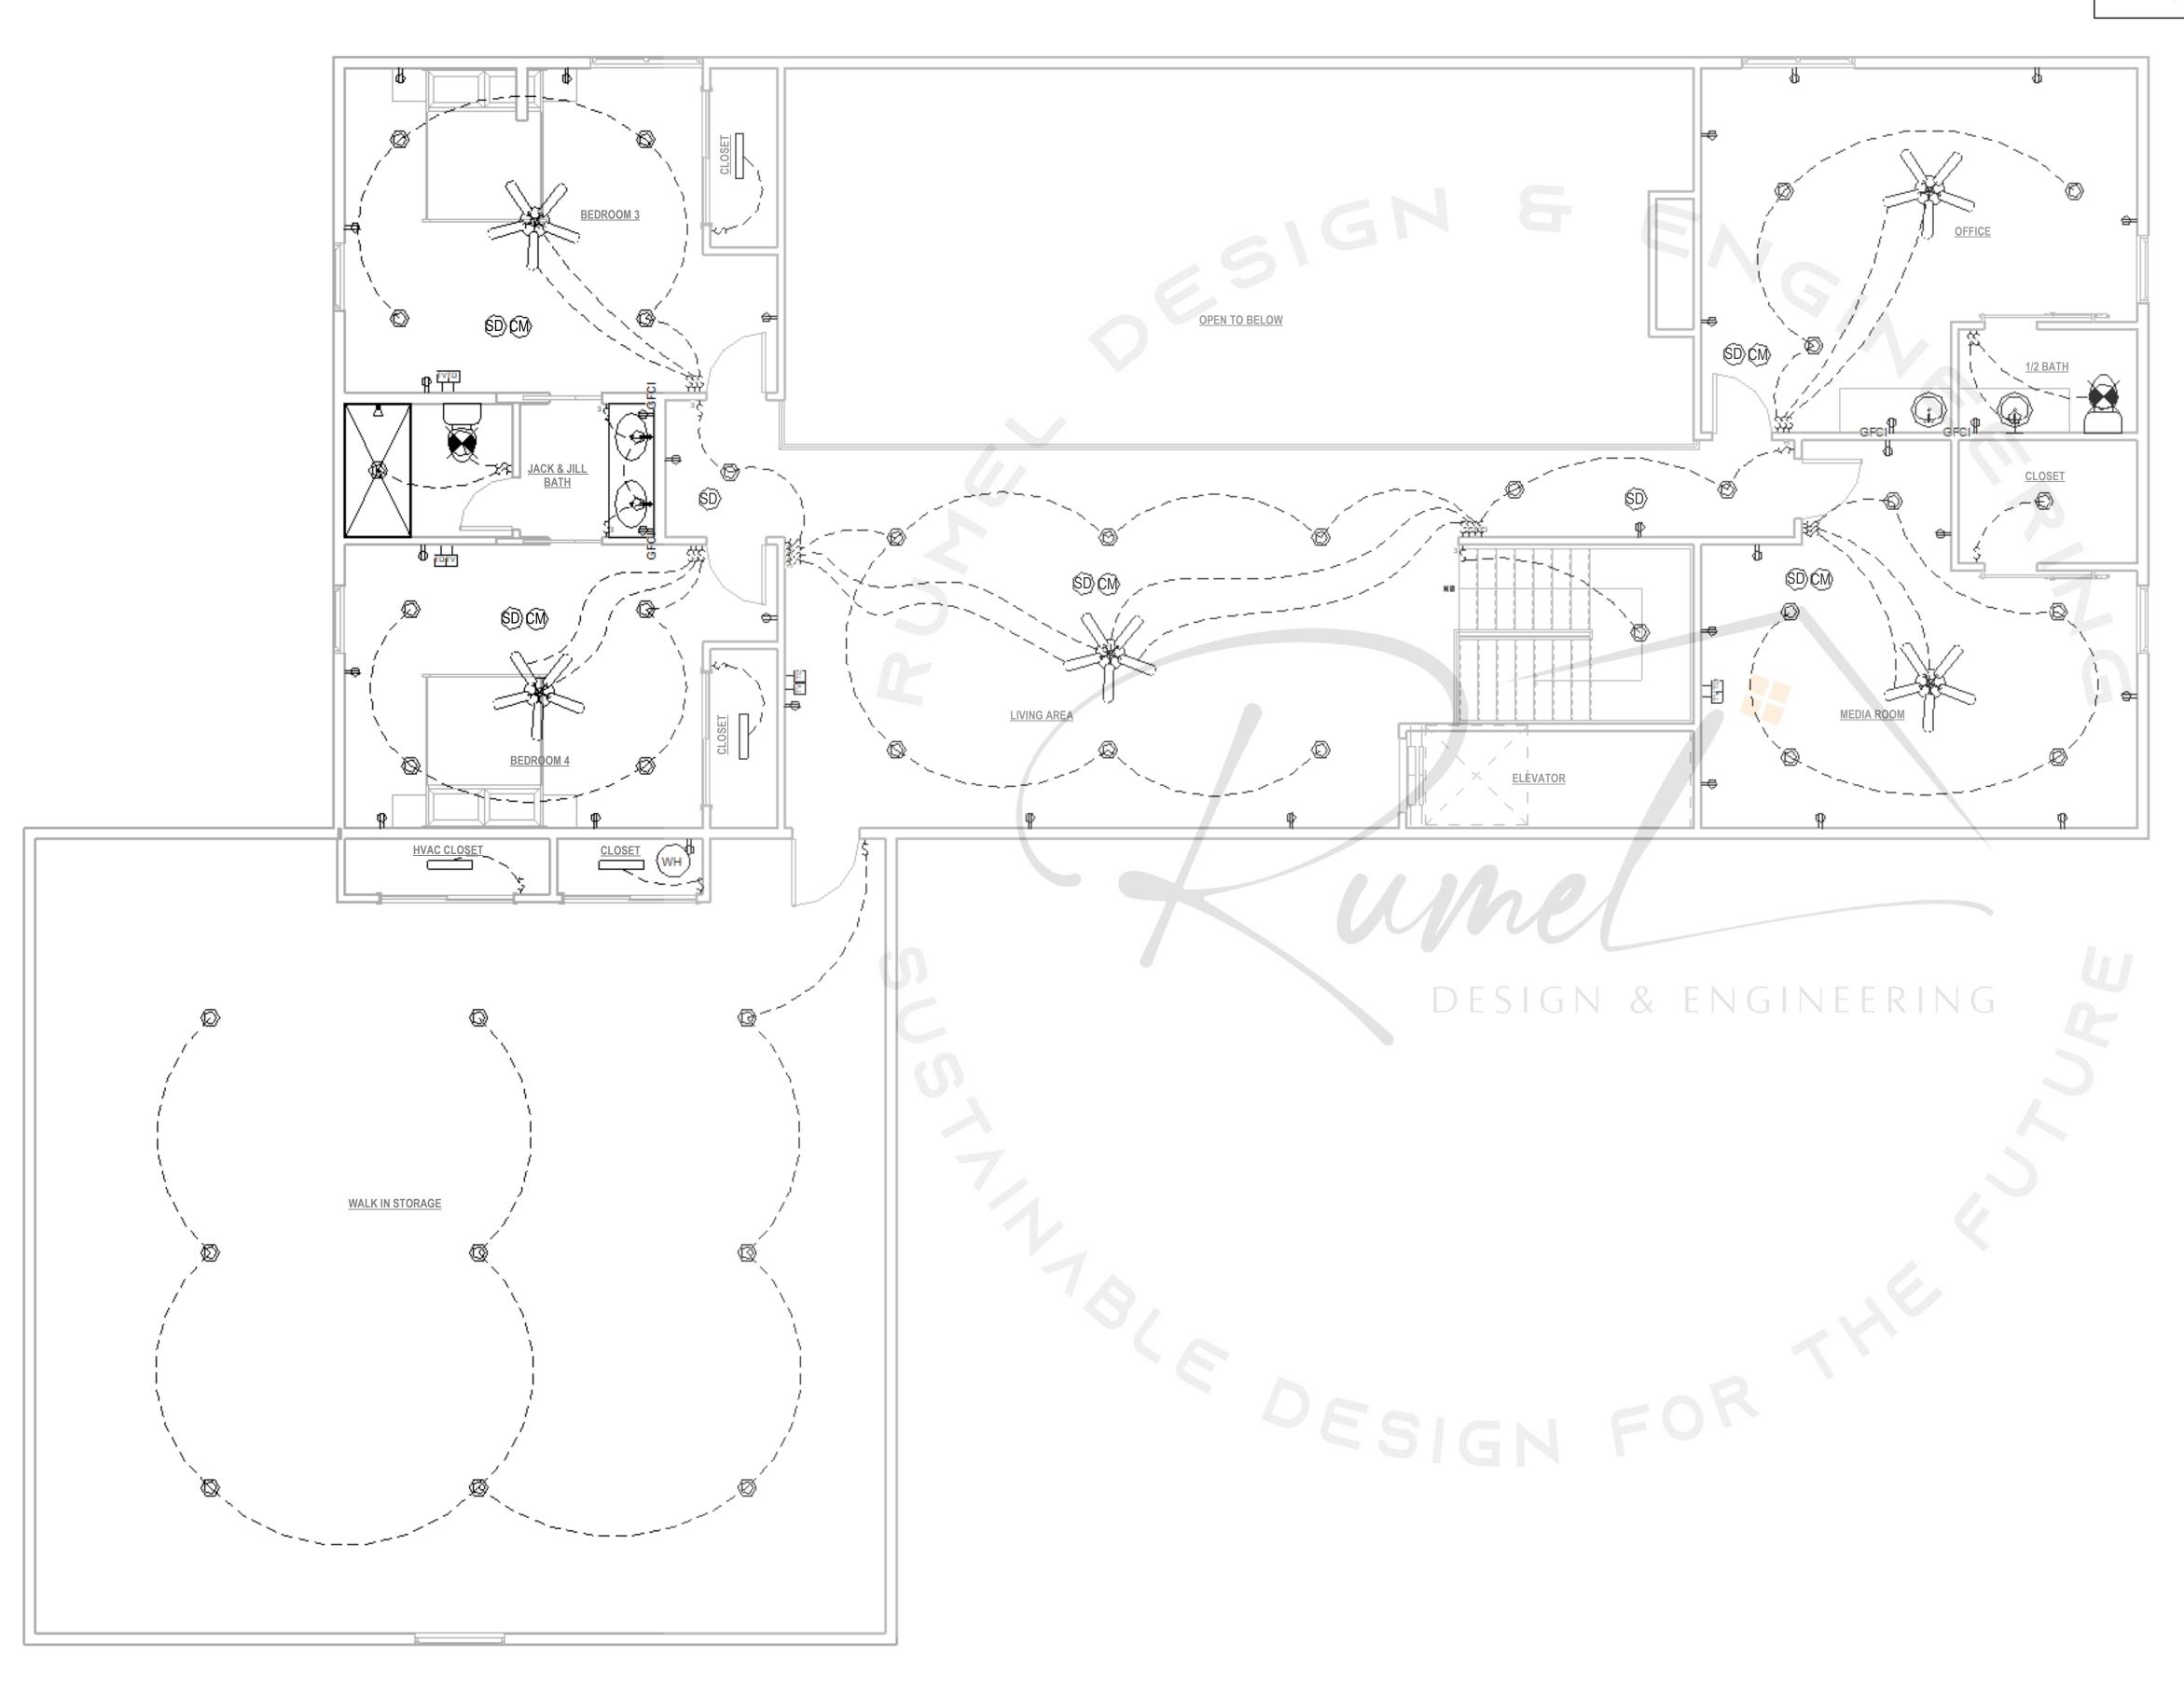

1 Second Floor Electrical Plan 1/4" = 1'-0"

CEILING FAN WITH LIGHT  TV CONNECTION  DATA JACK  TELEPHONE JACK  GFCI PROTECTED OUTLET  STANDARD 110V OUTLET  STANDARD 220V OUTLET  PROGRAMMABLE THERMOSTAT  LIGHT SWITCH  CEILING MOUND RADINAT HEATER  ELECTRICAL PANEL  WALL MOUNTED LIGHT FIXTURE  KALL MOUNTED LIGHT FIXTURE  RECESSED CEILING CAN  PENDANT LIGHT FIXTURE  LED STRIP LIGHT  EXHAUST FAN  SMOKE DETECTOR  CARBON MONOXIDE DETECTOR	ELEC	ELECTRICAL LEGEND		
DATA JACK TELEPHONE JACK GFCI PROTECTED OUTLET STANDARD 110V OUTLET STANDARD 220V OUTLET PROGRAMMABLE THERMOSTAT LIGHT SWITCH S-WAY LIGHT SWITCH CEILING MOUND RADINAT HEATER FLECTRICAL PANEL WALL MOUNTED LIGHT FIXTURE FLOOD LIGHT FIXTURE RECESSED CEILING CAN PENDANT LIGHT FIXTURE LED STRIP LIGHT EXHAUST FAN EXHAUST FAN SMOKE DETECTOR	*	CEILING FAN WITH LIGHT		
TELEPHONE JACK  GFCI PROTECTED OUTLET  STANDARD 110V OUTLET  STANDARD 220V OUTLET  PROGRAMMABLE THERMOSTAT  LIGHT SWITCH  3-WAY LIGHT SWITCH  CEILING MOUND RADINAT HEATER  ELECTRICAL PANEL  WALL MOUNTED LIGHT FIXTURE  RECESSED CEILING CAN  PENDANT LIGHT FIXTURE  RECESSED CEILING CAN  EXHAUST FAN  SMOKE DETECTOR	P	TV CONNECTION		
GFCI PROTECTED OUTLET  STANDARD 110V OUTLET  STANDARD 220V OUTLET  PROGRAMMABLE THERMOSTAT  LIGHT SWITCH  3-WAY LIGHT SWITCH  CEILING MOUND RADINAT HEATER  ELECTRICAL PANEL  WALL MOUNTED LIGHT FIXTURE  RECESSED CEILING CAN  PENDANT LIGHT FIXTURE  LED STRIP LIGHT  EXHAUST FAN  SMOKE DETECTOR		DATA JACK		
STANDARD 110V OUTLET  STANDARD 220V OUTLET  PROGRAMMABLE THERMOSTAT  LIGHT SWITCH  3-WAY LIGHT SWITCH  CEILING MOUND RADINAT HEATER  ELECTRICAL PANEL  WALL MOUNTED LIGHT FIXTURE  KECESSED CEILING CAN  PENDANT LIGHT FIXTURE  LED STRIP LIGHT  EXHAUST FAN  SMOKE DETECTOR	7	TELEPHONE JACK		
STANDARD 220V OUTLET  PROGRAMMABLE THERMOSTAT  LIGHT SWITCH  3-WAY LIGHT SWITCH  CEILING MOUND RADINAT HEATER  ELECTRICAL PANEL  WALL MOUNTED LIGHT FIXTURE  FLOOD LIGHT FIXTURE  RECESSED CEILING CAN  PENDANT LIGHT FIXTURE  LED STRIP LIGHT  EXHAUST FAN  SMOKE DETECTOR	#GFCI	GFCI PROTECTED OUTLET		
PROGRAMMABLE THERMOSTAT  IGHT SWITCH  3-WAY LIGHT SWITCH  CEILING MOUND RADINAT HEATER  ELECTRICAL PANEL  WALL MOUNTED LIGHT FIXTURE  FLOOD LIGHT FIXTURE  RECESSED CEILING CAN  PENDANT LIGHT FIXTURE  LED STRIP LIGHT  EXHAUST FAN  SMOKE DETECTOR	⇔	STANDARD 110V OUTLET		
LIGHT SWITCH  3-WAY LIGHT SWITCH  CEILING MOUND RADINAT HEATER  ELECTRICAL PANEL  WALL MOUNTED LIGHT FIXTURE  FLOOD LIGHT FIXTURE  RECESSED CEILING CAN  PENDANT LIGHT FIXTURE  LED STRIP LIGHT  EXHAUST FAN  SMOKE DETECTOR	<del></del>	STANDARD 220V OUTLET		
3-WAY LIGHT SWITCH  CEILING MOUND RADINAT HEATER  ELECTRICAL PANEL  WALL MOUNTED LIGHT FIXTURE  FLOOD LIGHT FIXTURE  RECESSED CEILING CAN  PENDANT LIGHT FIXTURE  LED STRIP LIGHT  EXHAUST FAN  SMOKE DETECTOR	<u></u>	PROGRAMMABLE THERMOSTAT		
CEILING MOUND RADINAT HEATER  ELECTRICAL PANEL  WALL MOUNTED LIGHT FIXTURE  FLOOD LIGHT FIXTURE  RECESSED CEILING CAN  PENDANT LIGHT FIXTURE  LED STRIP LIGHT  EXHAUST FAN  SMOKE DETECTOR	ş	LIGHT SWITCH		
➡ ELECTRICAL PANEL   ➡ WALL MOUNTED LIGHT FIXTURE   ☒ FLOOD LIGHT FIXTURE   ☒ RECESSED CEILING CAN   ➡ PENDANT LIGHT FIXTURE   ➡ LED STRIP LIGHT   ☒ EXHAUST FAN   ☒ EXHAUST FAN / LIGHT   ☒ SMOKE DETECTOR	Ş	3-WAY LIGHT SWITCH		
WALL MOUNTED LIGHT FIXTURE  FLOOD LIGHT FIXTURE  RECESSED CEILING CAN  PENDANT LIGHT FIXTURE  LED STRIP LIGHT  EXHAUST FAN  EXHAUST FAN / LIGHT  SD SMOKE DETECTOR		CEILING MOUND RADINAT HEATER		
FLOOD LIGHT FIXTURE  RECESSED CEILING CAN  PENDANT LIGHT FIXTURE  LED STRIP LIGHT  EXHAUST FAN  EXHAUST FAN / LIGHT  SD SMOKE DETECTOR	7	ELECTRICAL PANEL		
RECESSED CEILING CAN  PENDANT LIGHT FIXTURE  LED STRIP LIGHT  EXHAUST FAN  EXHAUST FAN / LIGHT  SD SMOKE DETECTOR	Ю	WALL MOUNTED LIGHT FIXTURE		
PENDANT LIGHT FIXTURE  LED STRIP LIGHT  EXHAUST FAN  EXHAUST FAN / LIGHT  SD SMOKE DETECTOR	¤	FLOOD LIGHT FIXTURE		
LED STRIP LIGHT  EXHAUST FAN  EXHAUST FAN / LIGHT  SD SMOKE DETECTOR	0	RECESSED CEILING CAN		
EXHAUST FAN / LIGHT  SD SMOKE DETECTOR	<del>+</del>	PENDANT LIGHT FIXTURE		
EXHAUST FAN / LIGHT  SD SMOKE DETECTOR		LED STRIP LIGHT		
SMOKE DETECTOR	Ħ	EXHAUST FAN		
	æ	EXHAUST FAN / LIGHT		
CM CARBON MONOXIDE DETECTOR	(SD)	SMOKE DETECTOR		
	(M)	CARBON MONOXIDE DETECTOR		



\*\*GET WHAT YOU ARE LOOKING FOR\*\*

© COPYRIGHT BY RUMEL DESIGN \$ ENGINEERING ALL RIGHTS RESERVED. PLEASE NOTE: Rumel design & Engineering. assumes no liability for any structure constructed from this plan. It is the responsibility of the contractor to perform the following before beginning construction:

1) Contractor must verify ALL Dimensions on sheets and in field prior to proceeding with construction.

2) Contractor must verify compliance with ALL Local Building Codes in the area the project is to be constructed.

3) Plans indicate locations only, building engineering aspect should incorporate actual site conditions shown on a Survey provided by Owners Consultant

REVISION SCHEDULE: NO. DESCRIPTION DATE PROJECT NUMBER:

PROJECT OWNERS:

CONTRACTOR:

SECOND FLOOR

ELECTRICAL PLAN


CHECKED BY

Project Status

DOCUMENT ISSUED 5/29/2025 10:06:17 PM

SCALE: As indicated

ARCH D 24" X 36" SHEET NO.

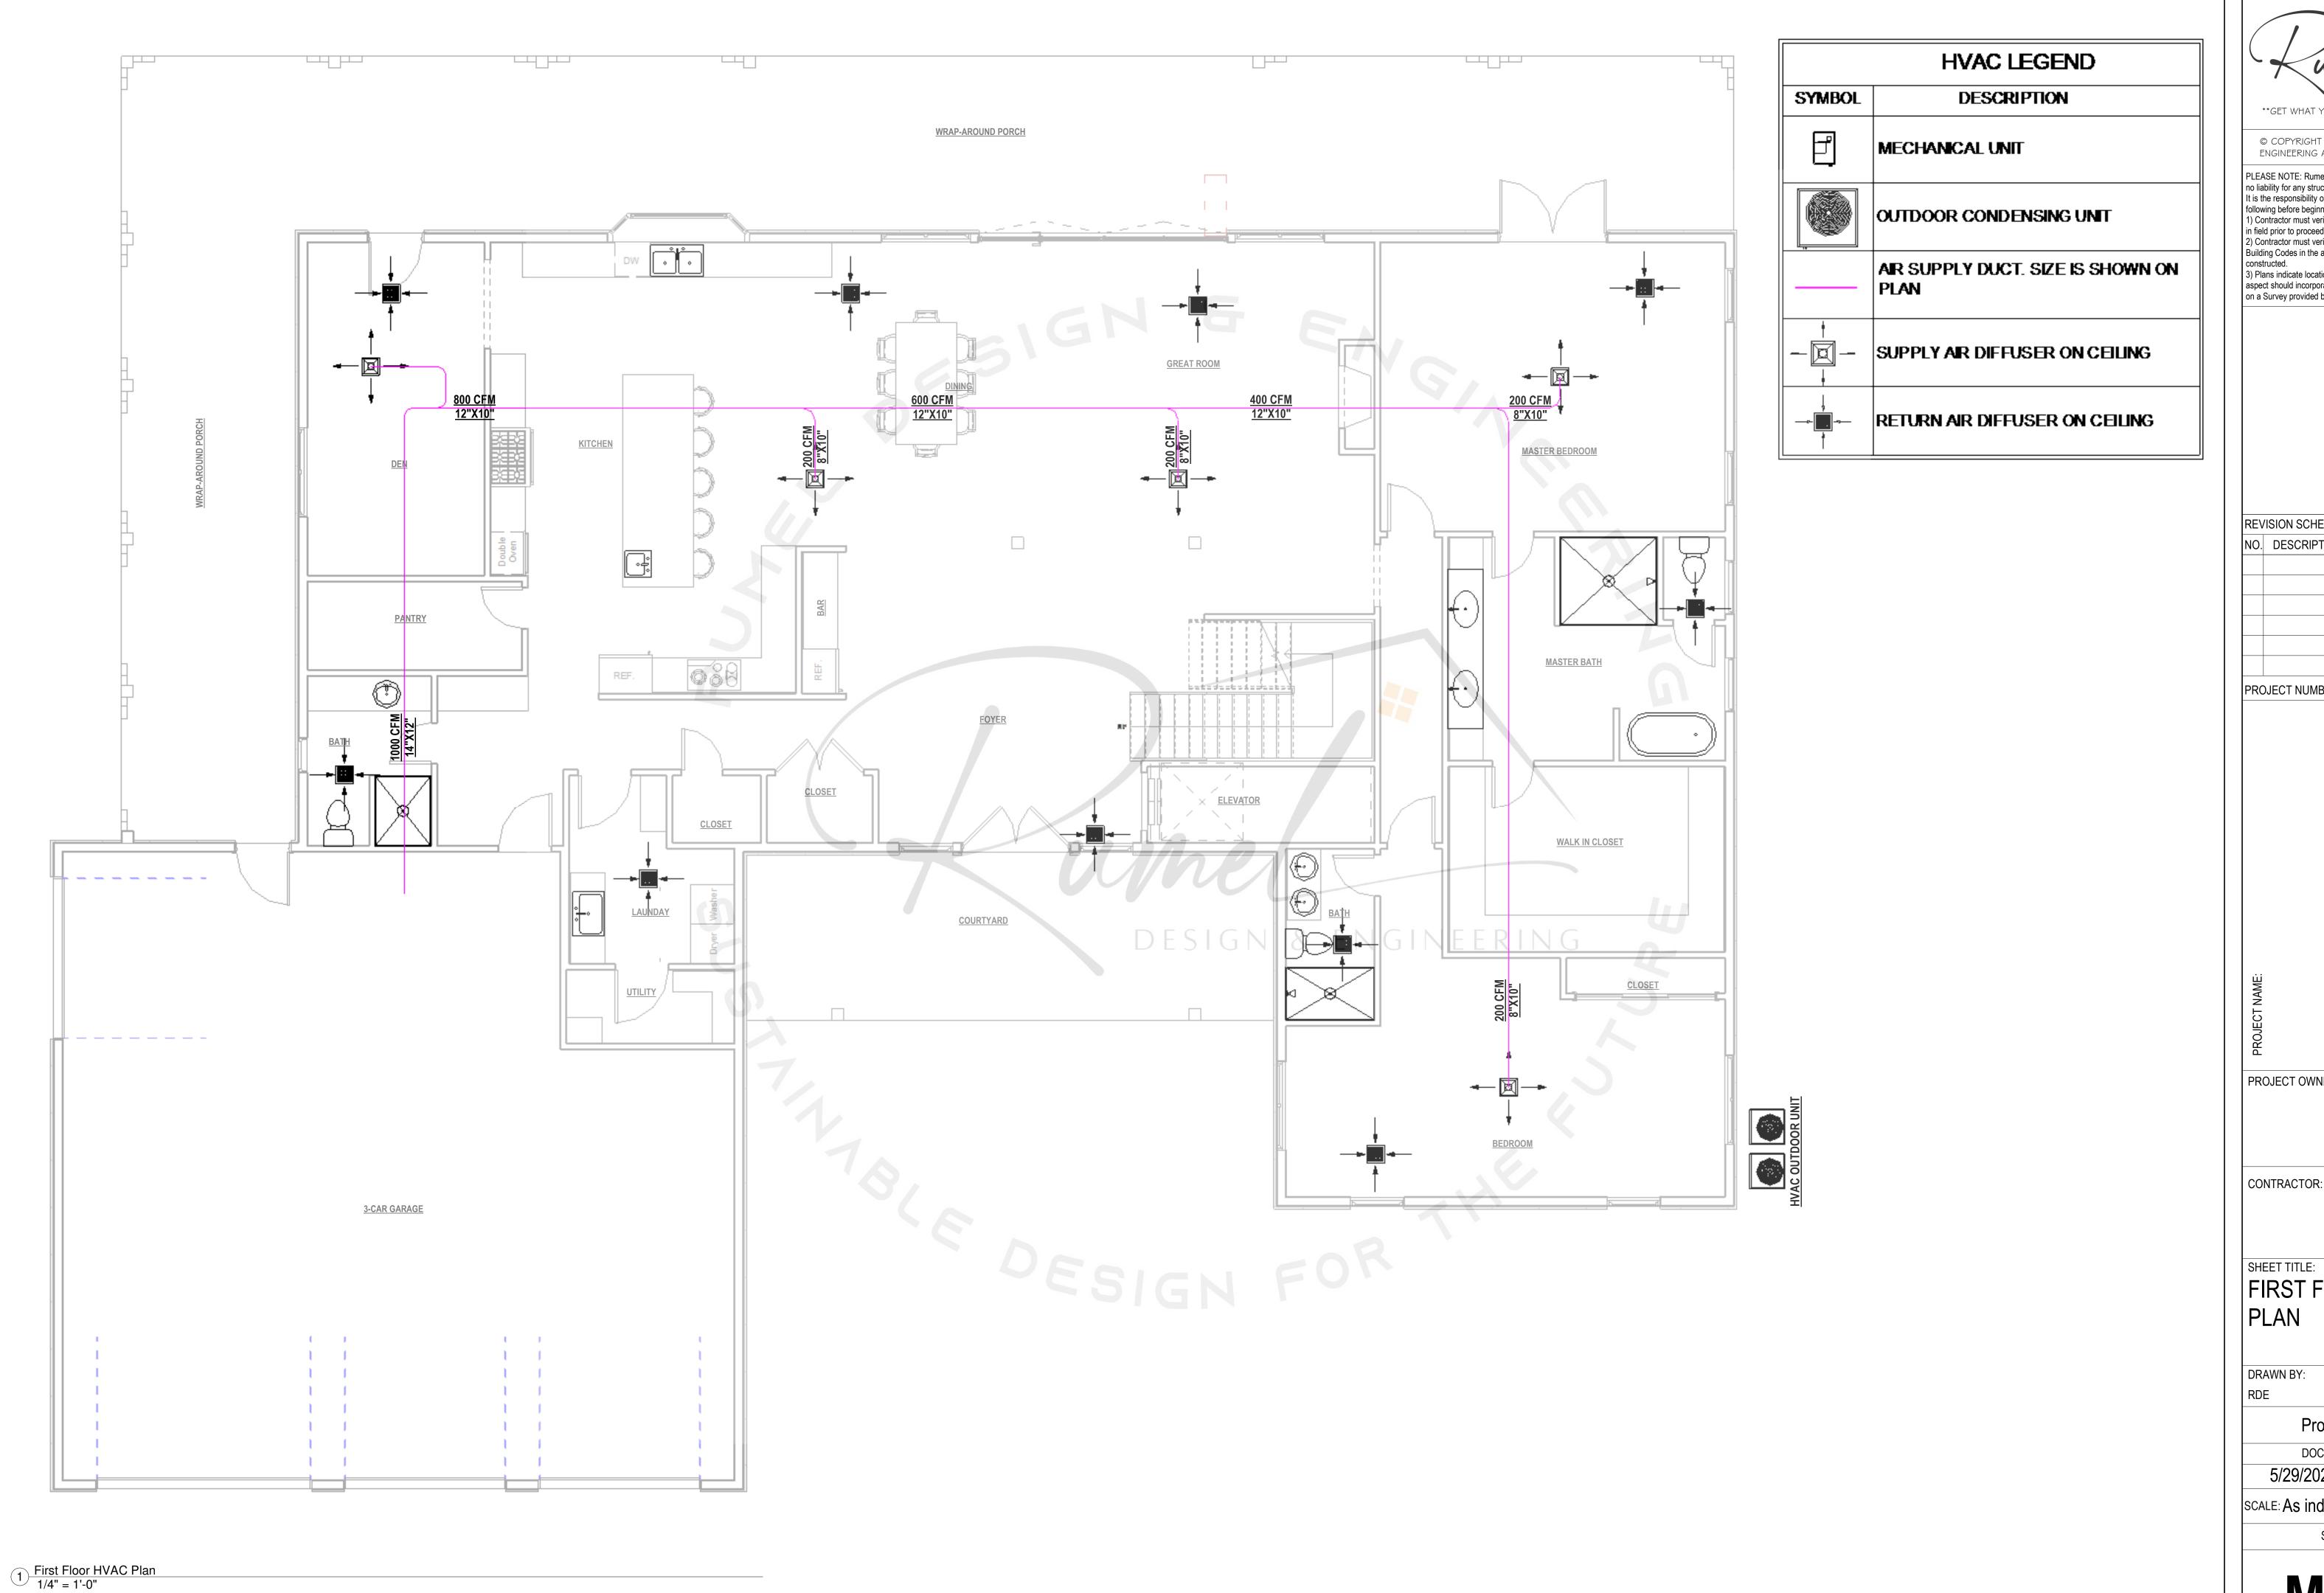

\*\*GET WHAT YOU ARE LOOKING FOR\*\*

© COPYRIGHT BY RUMEL DESIGN & ENGINEERING ALL RIGHTS RESERVED.

PLEASE NOTE: Rumel design & Engineering. assumes no liability for any structure constructed from this plan. It is the responsibility of the contractor to perform the following before beginning construction:

1) Contractor must verify ALL Dimensions on sheets and in field prior to proceeding with construction.

2) Contractor must verify compliance with ALL Local Building Codes in the area the project is to be constructed.

3) Plans indicate locations only, building engineering.

Plans indicate locations only, building engineering aspect should incorporate actual site conditions shown on a Survey provided by Owners Consultant

REVISION SCHEDULE:

DATE NO. DESCRIPTION

PROJECT NUMBER:

PROJECT OWNERS:

FIRST FLOOR HVAC

CHECKED BY:


**Project Status** 

DOCUMENT ISSUED

5/29/2025 10:06:17 PM

SCALE: As indicated

ARCH D 24" X 36" SHEET NO.

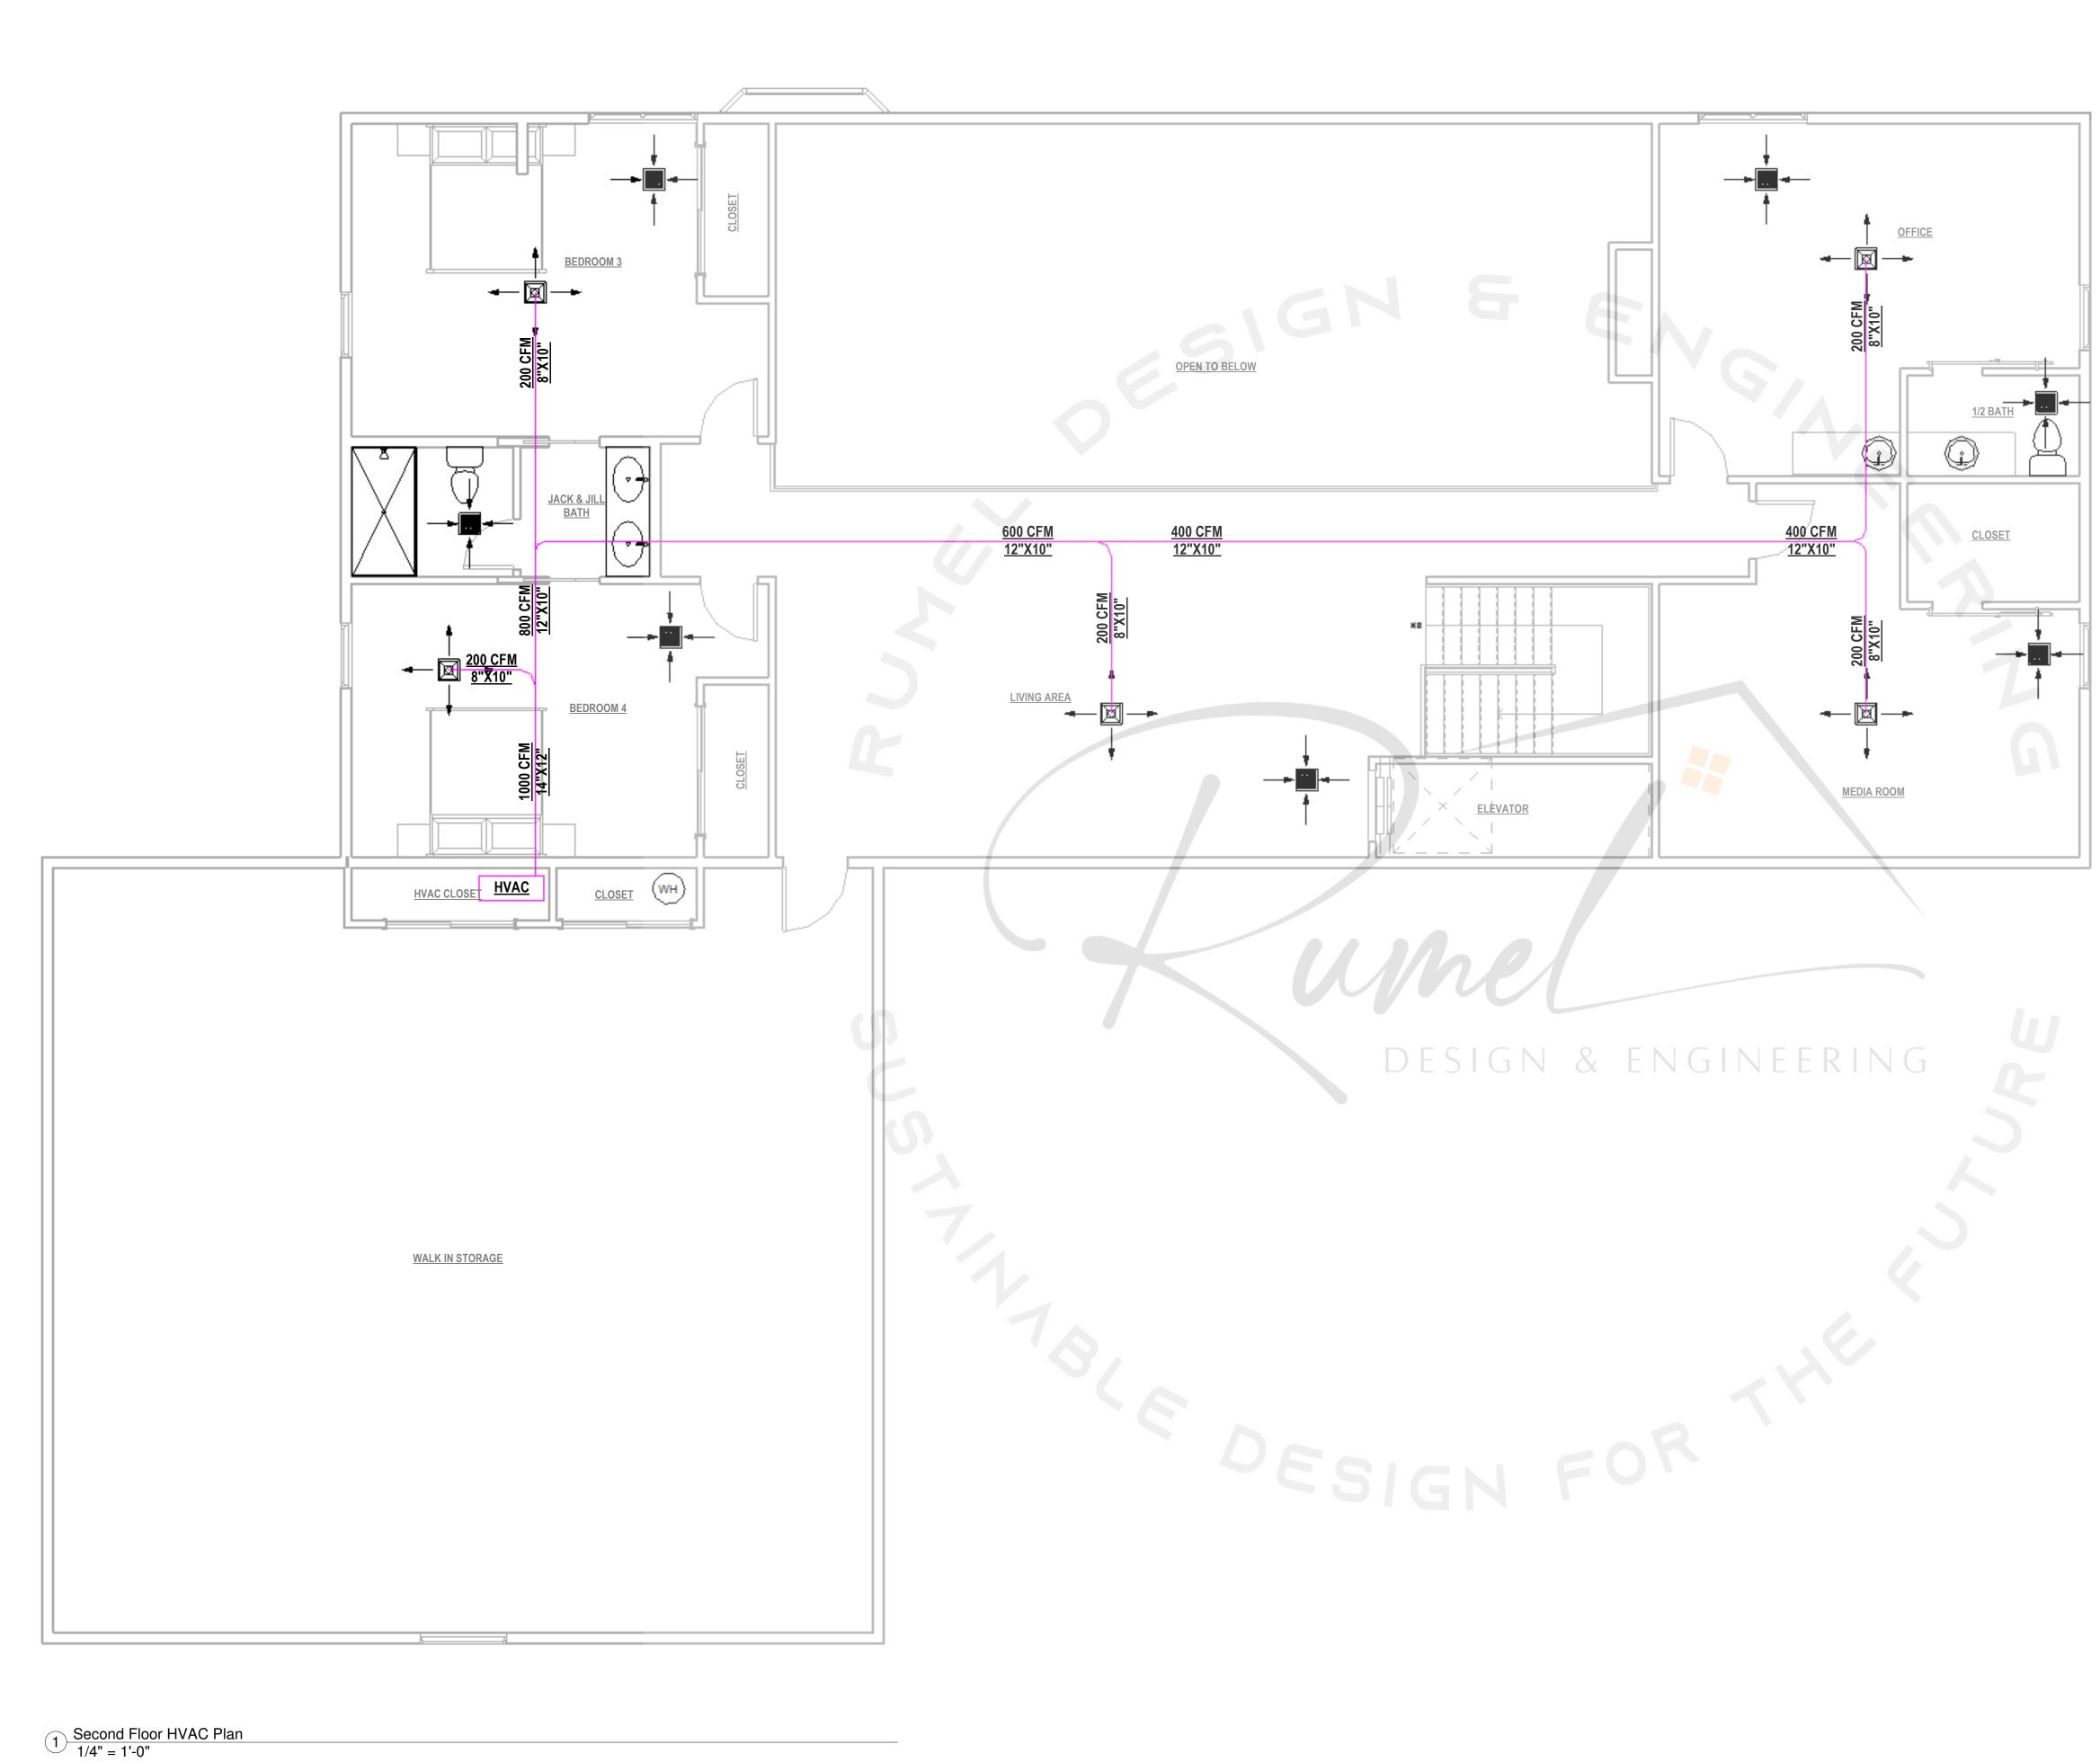

	HVAC LEGEND
SYMBOL	DESCRIPTION
ð	MECHANICAL UNIT
	OUTDOOR CONDENSING UNIT
	AIR SUPPLY DUCT. SIZE IS SHOWN ON PLAN
1	SUPPLY AIR DIFFUSER ON CEILING
	RETURN AIR DIFFUSER ON CEILING

\*\*GET WHAT YOU ARE LOOKING FOR\*\*

© COPYRIGHT BY RUMEL DESIGN \$ ENGINEERING ALL RIGHTS RESERVED.

PLEASE NOTE: Rumel design & Engineering. assumes no liability for any structure constructed from this plan. It is the responsibility of the contractor to perform the following before beginning construction:

1) Contractor must verify ALL Dimensions on sheets and in field prior to proceeding with construction.

2) Contractor must verify compliance with ALL Local Ruilding Codes in the area the project is to be Building Codes in the area the project is to be constructed.

3) Plans indicate locations only, building engineering aspect should incorporate actual site conditions shown on a Survey provided by Owners Consultant

REVISION SCHEDULE: DATE NO. DESCRIPTION

PROJECT NUMBER:

PROJECT OWNERS:

CONTRACTOR:

SECOND FLOOR HVAC PLAN

**Project Status** 


CHECKED BY:

DOCUMENT ISSUED

5/29/2025 10:06:18 PM

SCALE: As indicated

ARCH D 24" X 36" SHEET NO.

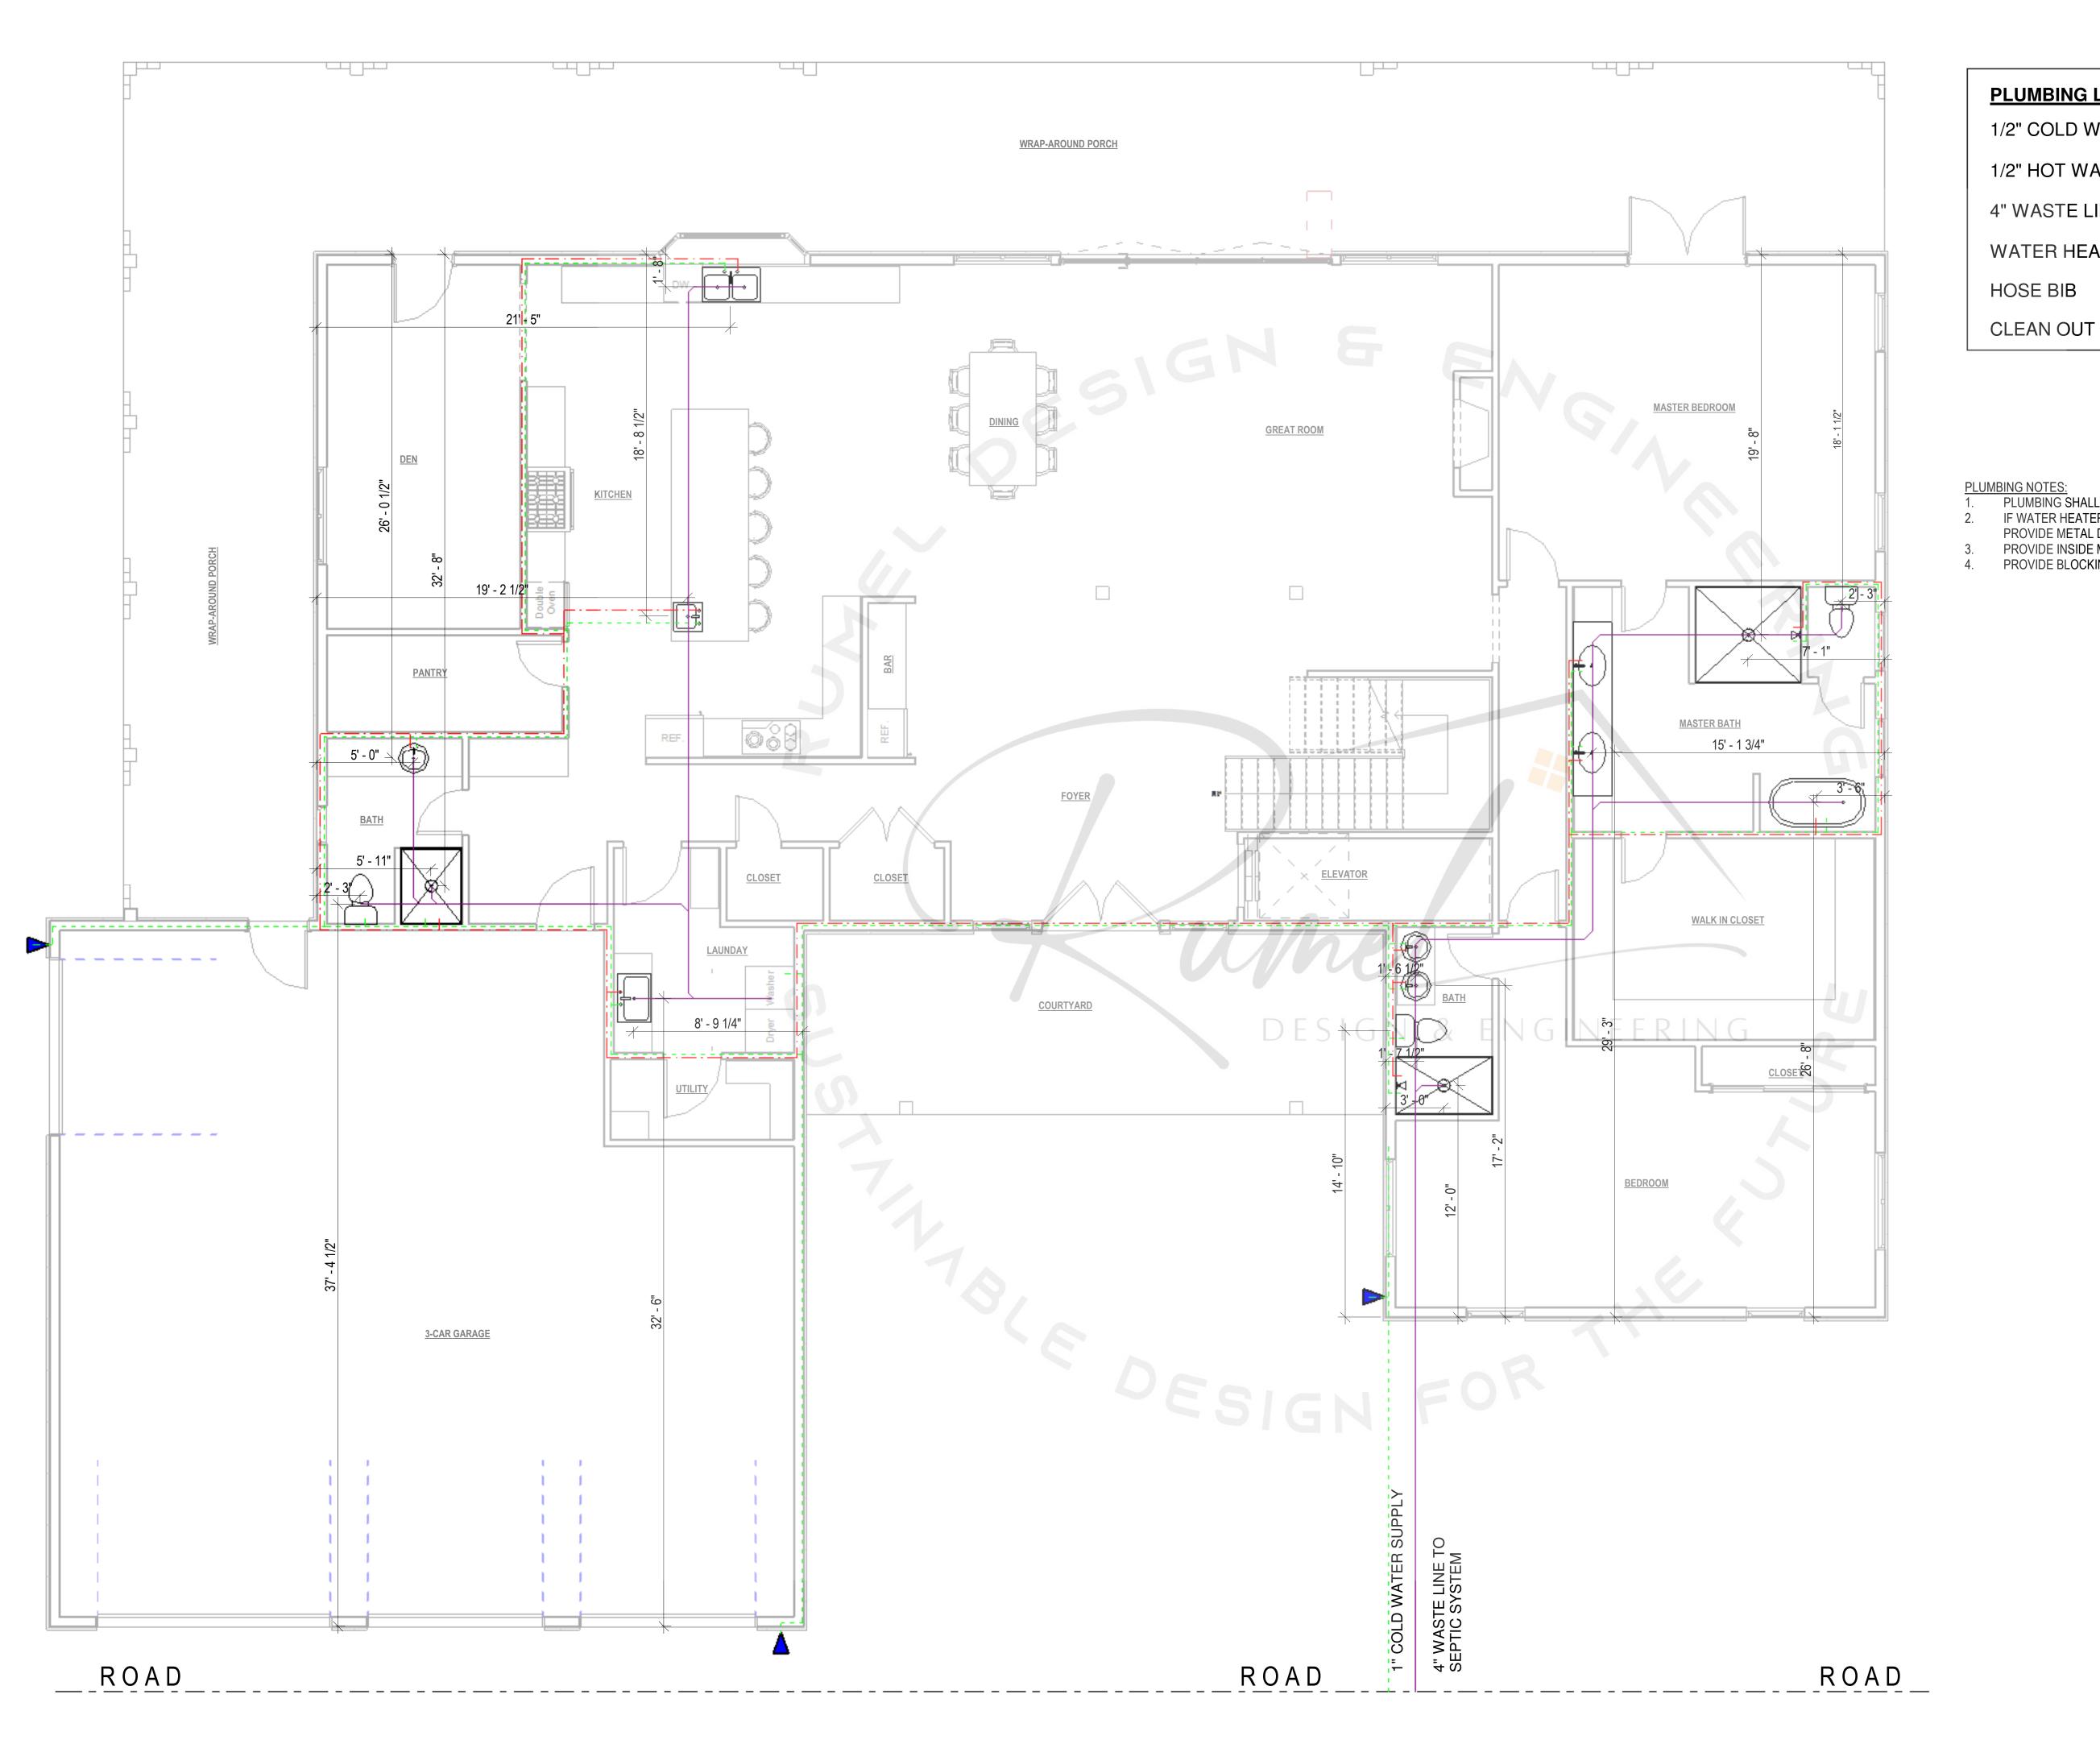

PLUMBING LEGENI	<u>D:</u>
1/2" COLD WATER	
1/2" HOT WATER	
4" WASTE LINE	
WATER HEATER	(W.H)
HOSE BIB	
CLEAN OUT	$_{\bigcirc}$

PLUMBING NOTES:

PLUMBING SHALL MEET ALL LOCAL CODES.

- IF WATER HEATER IS LOCATED ANYWHERE, EXCEPT GARAGE OR BASEMENT, PROVIDE METAL DRAIN PAN WITH AUXILLARY DRAIN TO EXTERIOR.
- PROVIDE INSIDE MAIN WATER CUT-OFF.
- PROVIDE BLOCKING IF WALL PLATES OR JOISTS ARE CUT INTO.

DESIGN & ENGINEERING

\*\*GET WHAT YOU ARE LOOKING FOR\*\*

© COPYRIGHT BY RUMEL DESIGN & ENGINEERING ALL RIGHTS RESERVED.

PLEASE NOTE: Rumel design & Engineering. assumes no liability for any structure constructed from this plan. It is the responsibility of the contractor to perform the following before beginning construction:

1) Contractor must verify ALL Dimensions on sheets and in field prior to proceeding with construction.

2) Contractor must verify compliance with ALL Local Building Codes in the area the project is to be constructed.

3) Plans indicate locations only, building engineering aspect should incorporate actual site conditions shown on a Survey provided by Owners Consultant

REVISION SCHEDULE:

NO. DESCRIPTION

DATE

PROJECT NUMBER:

PROJECT OWNERS:

CONTRACTOR:

SHEET TITLE:

FIRST FLOOR PLUMBING

**Project Status** 

CHECKED BY

ARCH D 24" X 36"


DOCUMENT ISSUED

5/29/2025 10:06:18 PM

SHEET NO.

SCALE: As indicated

First Floor Plumbing Plan
1/4" = 1'-0"

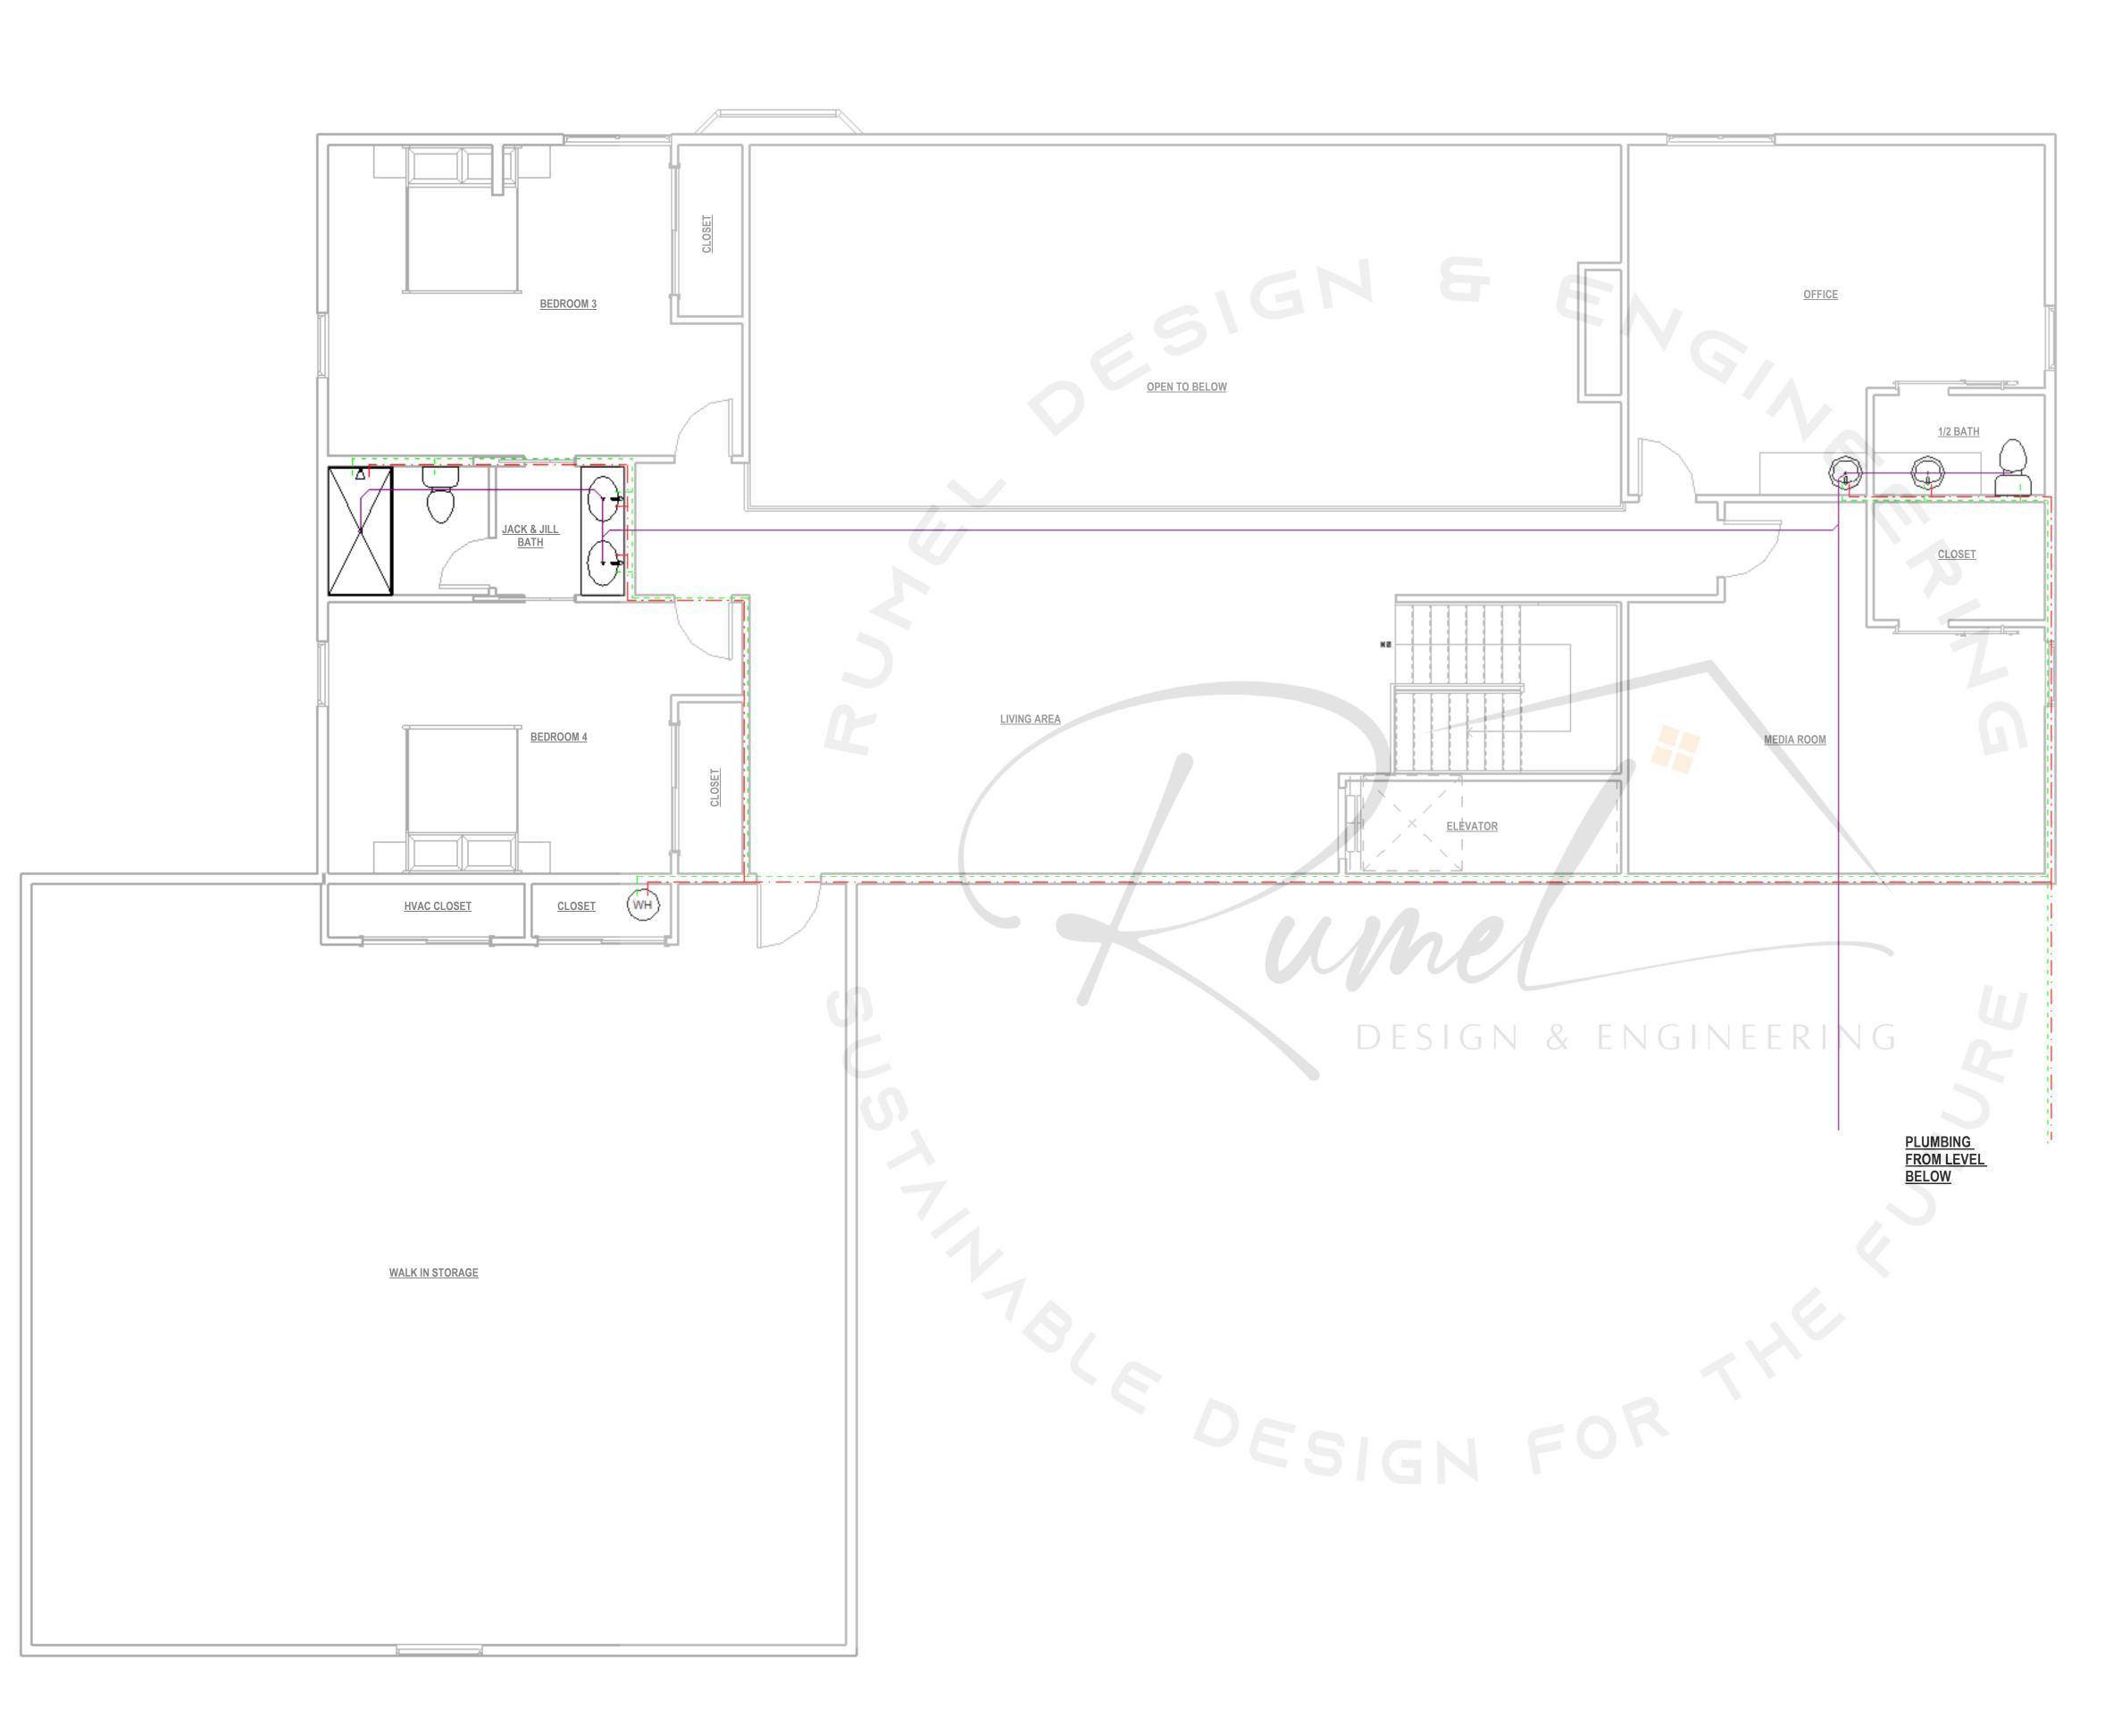

Second Floor Plumbing Plan
1/4" = 1'-0"

PLUMBING LEGENI	<u>D:</u>
1/2" COLD WATER	
1/2" HOT WATER	
4" WASTE LINE	
WATER HEATER	(W.H)
HOSE BIB	

PLUMBING NOTES:

PLUMBING SHALL MEET ALL LOCAL CODES.

**CLEAN OUT** 

2. IF WATER HEATER IS LOCATED ANYWHERE, EXCEPT GARAGE OR BASEMENT, PROVIDE METAL DRAIN PAN WITH AUXILLARY DRAIN TO EXTERIOR.

PROVIDE INSIDE MAIN WATER CUT-OFF.

PROVIDE BLOCKING IF WALL PLATES OR JOISTS ARE CUT INTO.

DESIGN & ENGINEERING

\*\*GET WHAT YOU ARE LOOKING FOR\*\*

© COPYRIGHT BY RUMEL DESIGN \$ ENGINEERING ALL RIGHTS RESERVED.

PLEASE NOTE: Rumel design & Engineering. assumes no liability for any structure constructed from this plan. It is the responsibility of the contractor to perform the following before beginning construction:

1) Contractor must verify ALL Dimensions on sheets and in field prior to proceeding with construction.

2) Contractor must verify compliance with ALL Local Building Codes in the area the project is to be constructed.

Plans indicate locations only, building engineering aspect should incorporate actual site conditions shown on a Survey provided by Owners Consultant

REVISION SCHEDULE:

NO. DESCRIPTION DATE

PROJECT NUMBER:

ECT NAME:

PROJECT OWNERS:

CONTRACTOR:

UCCT TITI C:

SECOND FLOOR PLUMBING PLAN

DRAWN BY

BY: CHECKED BY

**Project Status** 

DOCUMENT ISSUED


5/29/2025 10:06:19 PM

SCALE: As indicated

SHEET NO.

ARCH D 24" X 36"

P-2.0

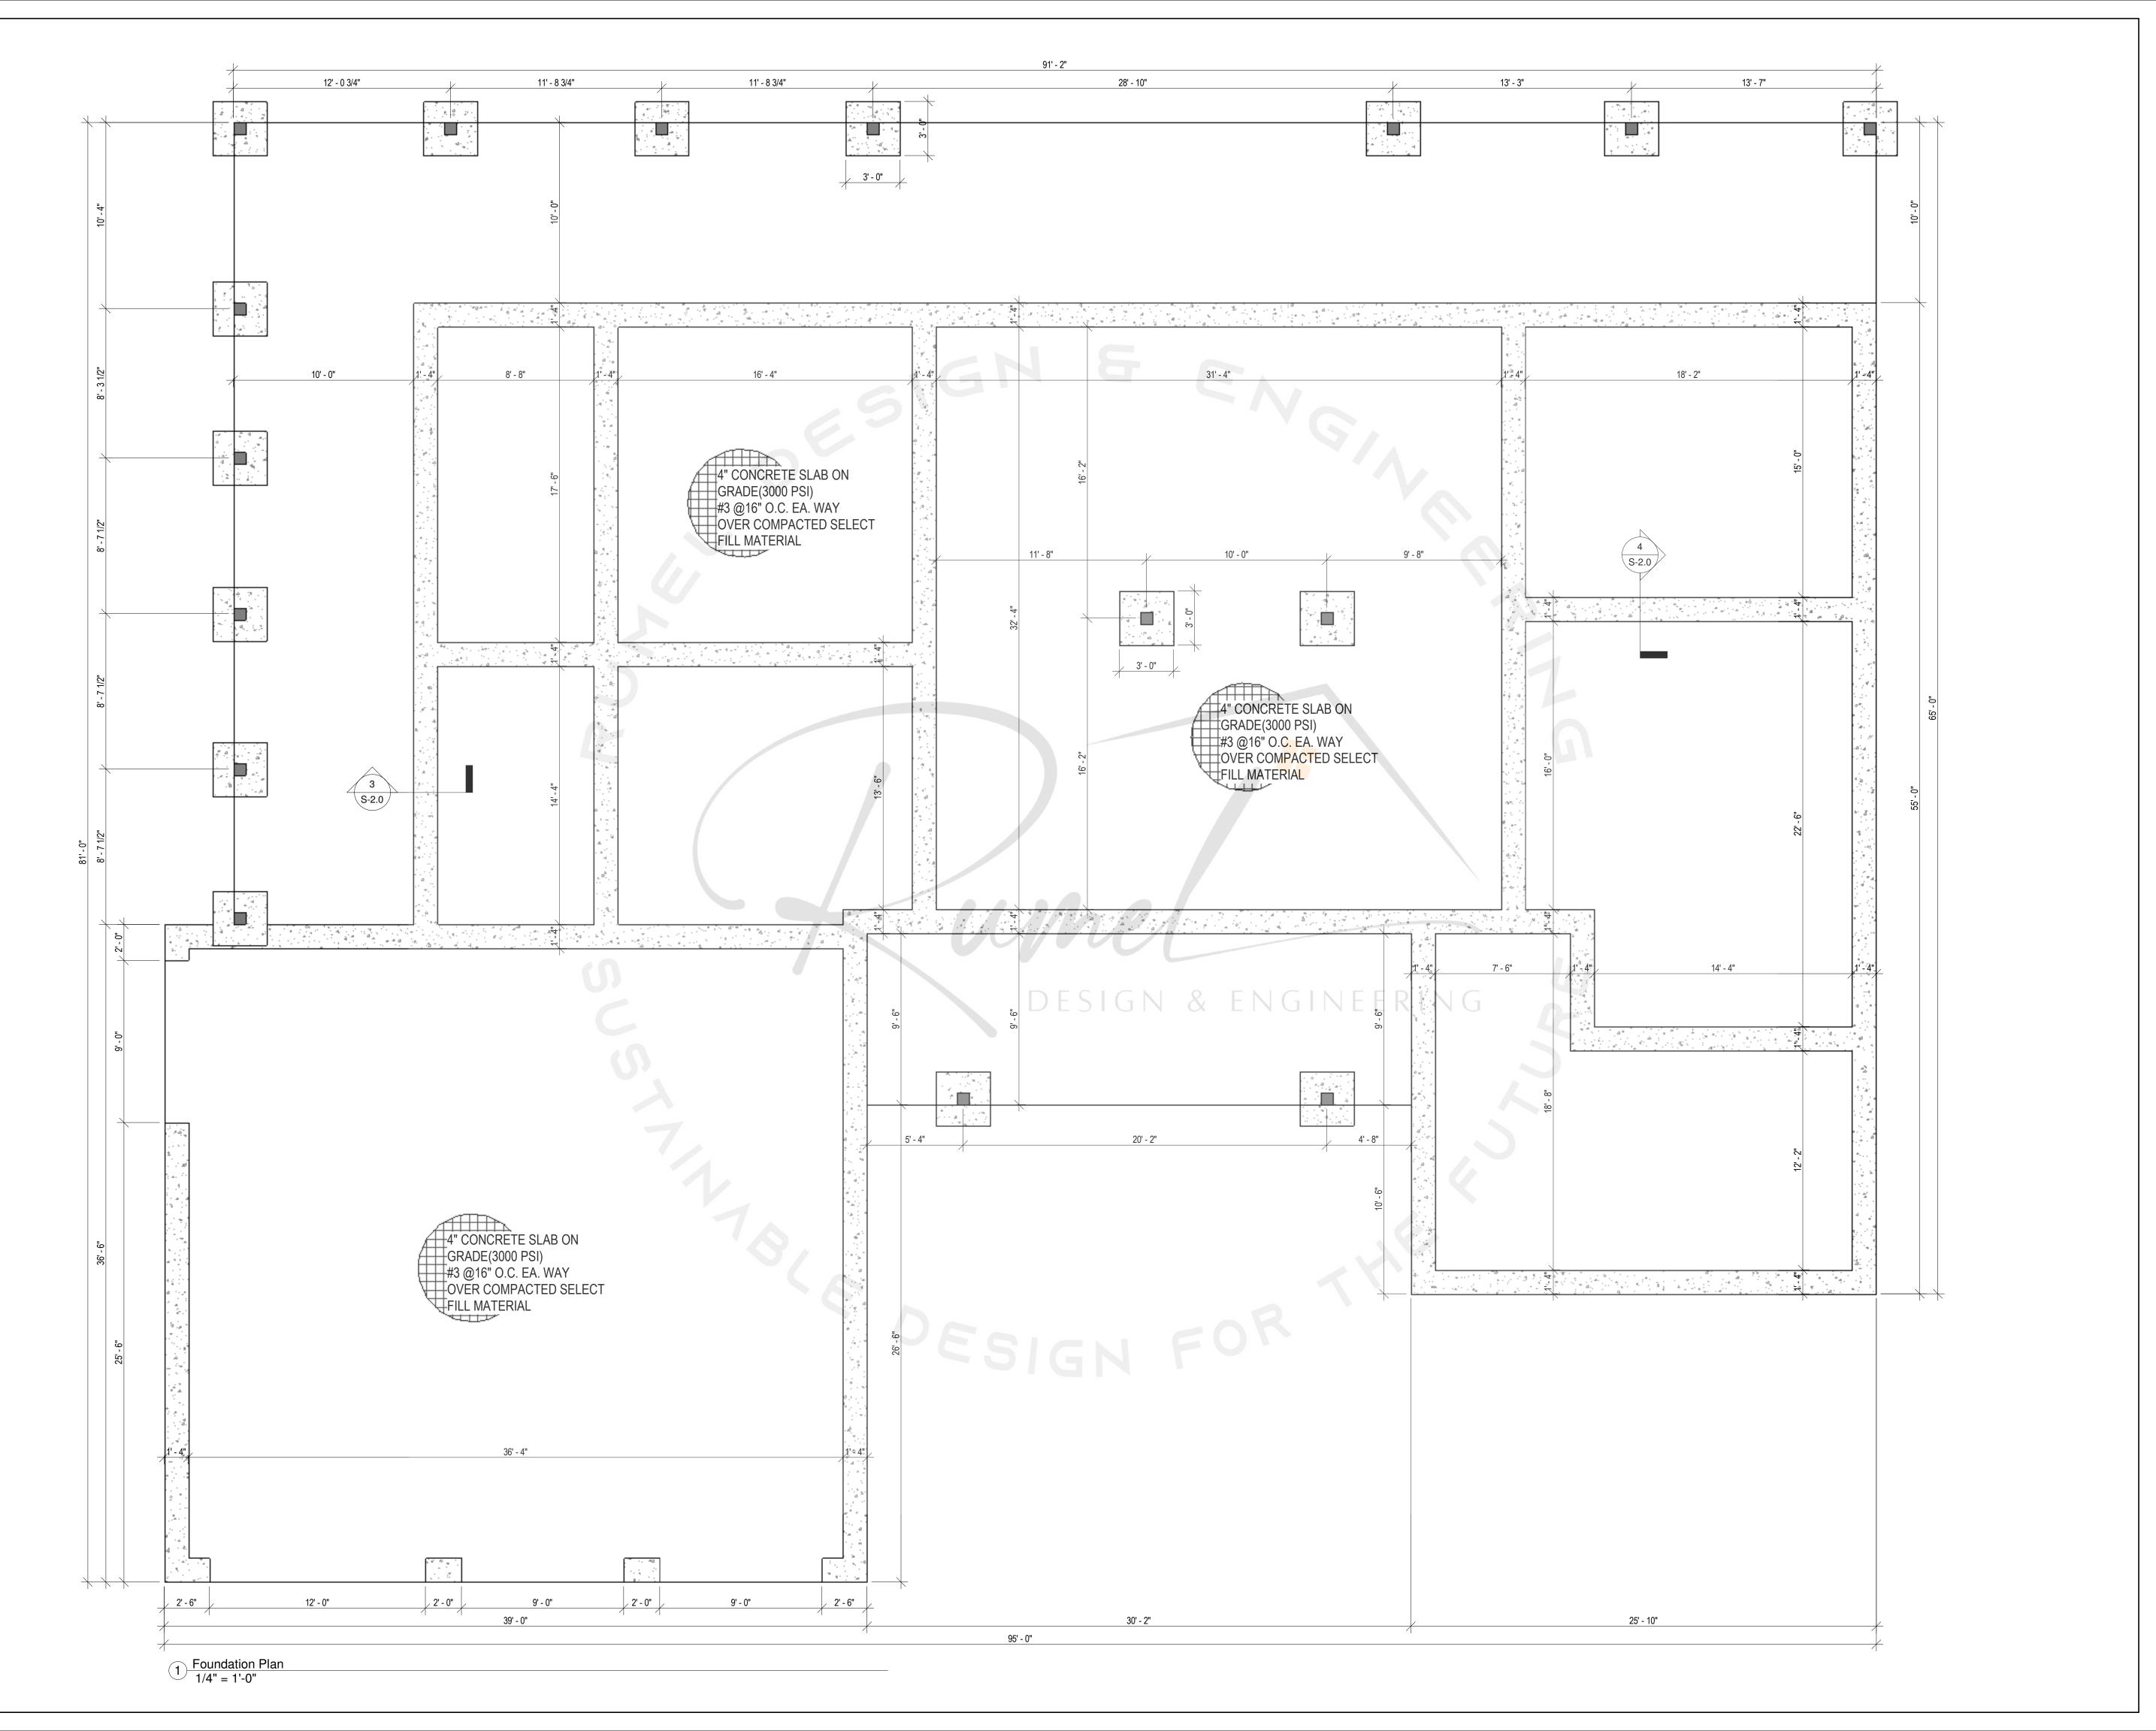

\*\*GET WHAT YOU ARE LOOKING FOR\*\*

© COPYRIGHT BY RUMEL DESIGN \$ ENGINEERING ALL RIGHTS RESERVED.

PLEASE NOTE: Rumel design & Engineering. assumes no liability for any structure constructed from this plan. It is the responsibility of the contractor to perform the following before beginning construction:

1) Contractor must verify ALL Dimensions on sheets and in field prior to proceeding with construction.

2) Contractor must verify compliance with ALL Local Building Codes in the area the project is to be constructed.

3) Plans indicate locations only, building engineering aspect should incorporate actual site conditions shown on a Survey provided by Owners Consultant

REVISION SCHEDULE:

NO. DESCRIPTION DATE

PROJECT NUMBER:

CT NAME:

PROJECT OWNERS:

CONTRACTOR:

SHEET TITLE:
FOUNDATION PLAN

Project Status

DOCUMENT ISSUED

CHECKED BY:

5/29/2025 10:06:19 PM

SCALE: 1/4" = 1'-0"

ARCH D 24" X 36"

SHEET NO.

S-1.0

### **FOUNDATION NOTE:**


#### SPECIFICATION NOTES

- 1. REINFORCED CONCRETE SHALL CONFORM TO APPLICABLE REQUIREMENTS OF THE 2012
- IRC. AND ALL LOCAL CITY OR COUNTY GUIDELINES.
  2. ALL CONCRETE USED IN THE FOUNDATIONS AND SLABS ON GRADE SHALL HAVE A 28 DAY
- COMPRESSIVE STRENGTH OF NOT LESS THAN 3.000 PSI.


  3. THE MAXIMUM SLUMP SHALL NOT EXCEED 4 INCHES.
- 4. PROVED CONTROL JOINT IN ALL EXPOSED SLABS ON GRADE THE MAXIMUM SPACING OF CONTROL JOINTS SHALL BE 20' O.G. UNLESS OTHERWISE NOTED.
- 5. A CIVIL ENGINEER SHOULD BE CONSULTED TO VERIFY FOUNDATION PLANS AND DELTAS. 6. ADD 6" BRICK LEDGE AROUND ALL SLAB


## SITE DRAINAGE:

IT IS RECOMMENDED THAT THE DRAINAGE BE WELL DEVELOPED. SURFACE WATER SHOULD BE DIRECTED AWAY FROM THE FOUNDATION SOILS. USE A MINIMUM SLOPE OF 2% WITHIN 10 FEET OF THE FOUNDATION, NO PONDING OF SURFACE WATER SHALL BE ALLOWED NEAR THE STRUCTURE DURING OR AFTER COMPLETION OF THE CONSTRUCTION AND THELANDSCAPING. THE BUILDER SHALL ADVISE THE OWNER OF THE SITE DRAINAGE REQUIREMENTS.

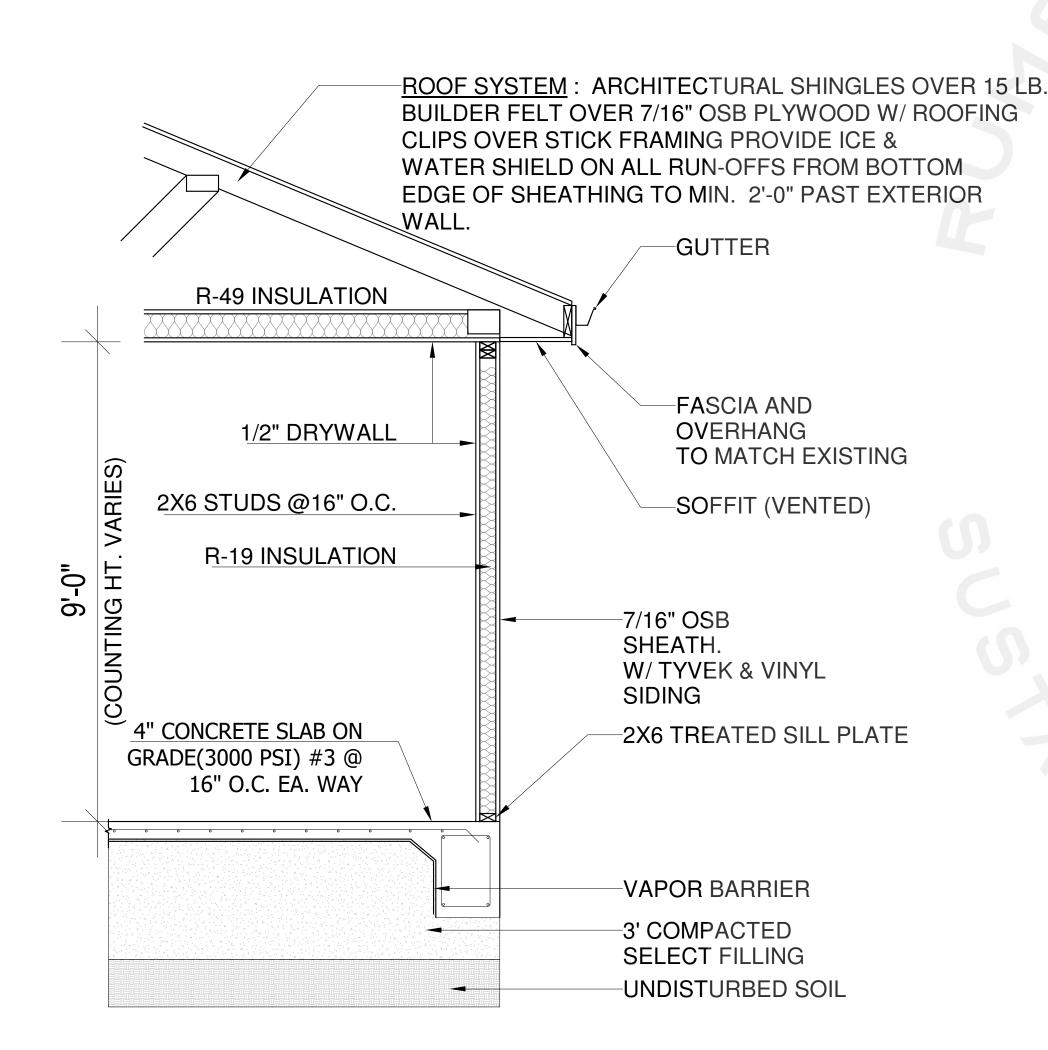

1 TYPICAL WALL SECTION -1
1/2" = 1'-0"

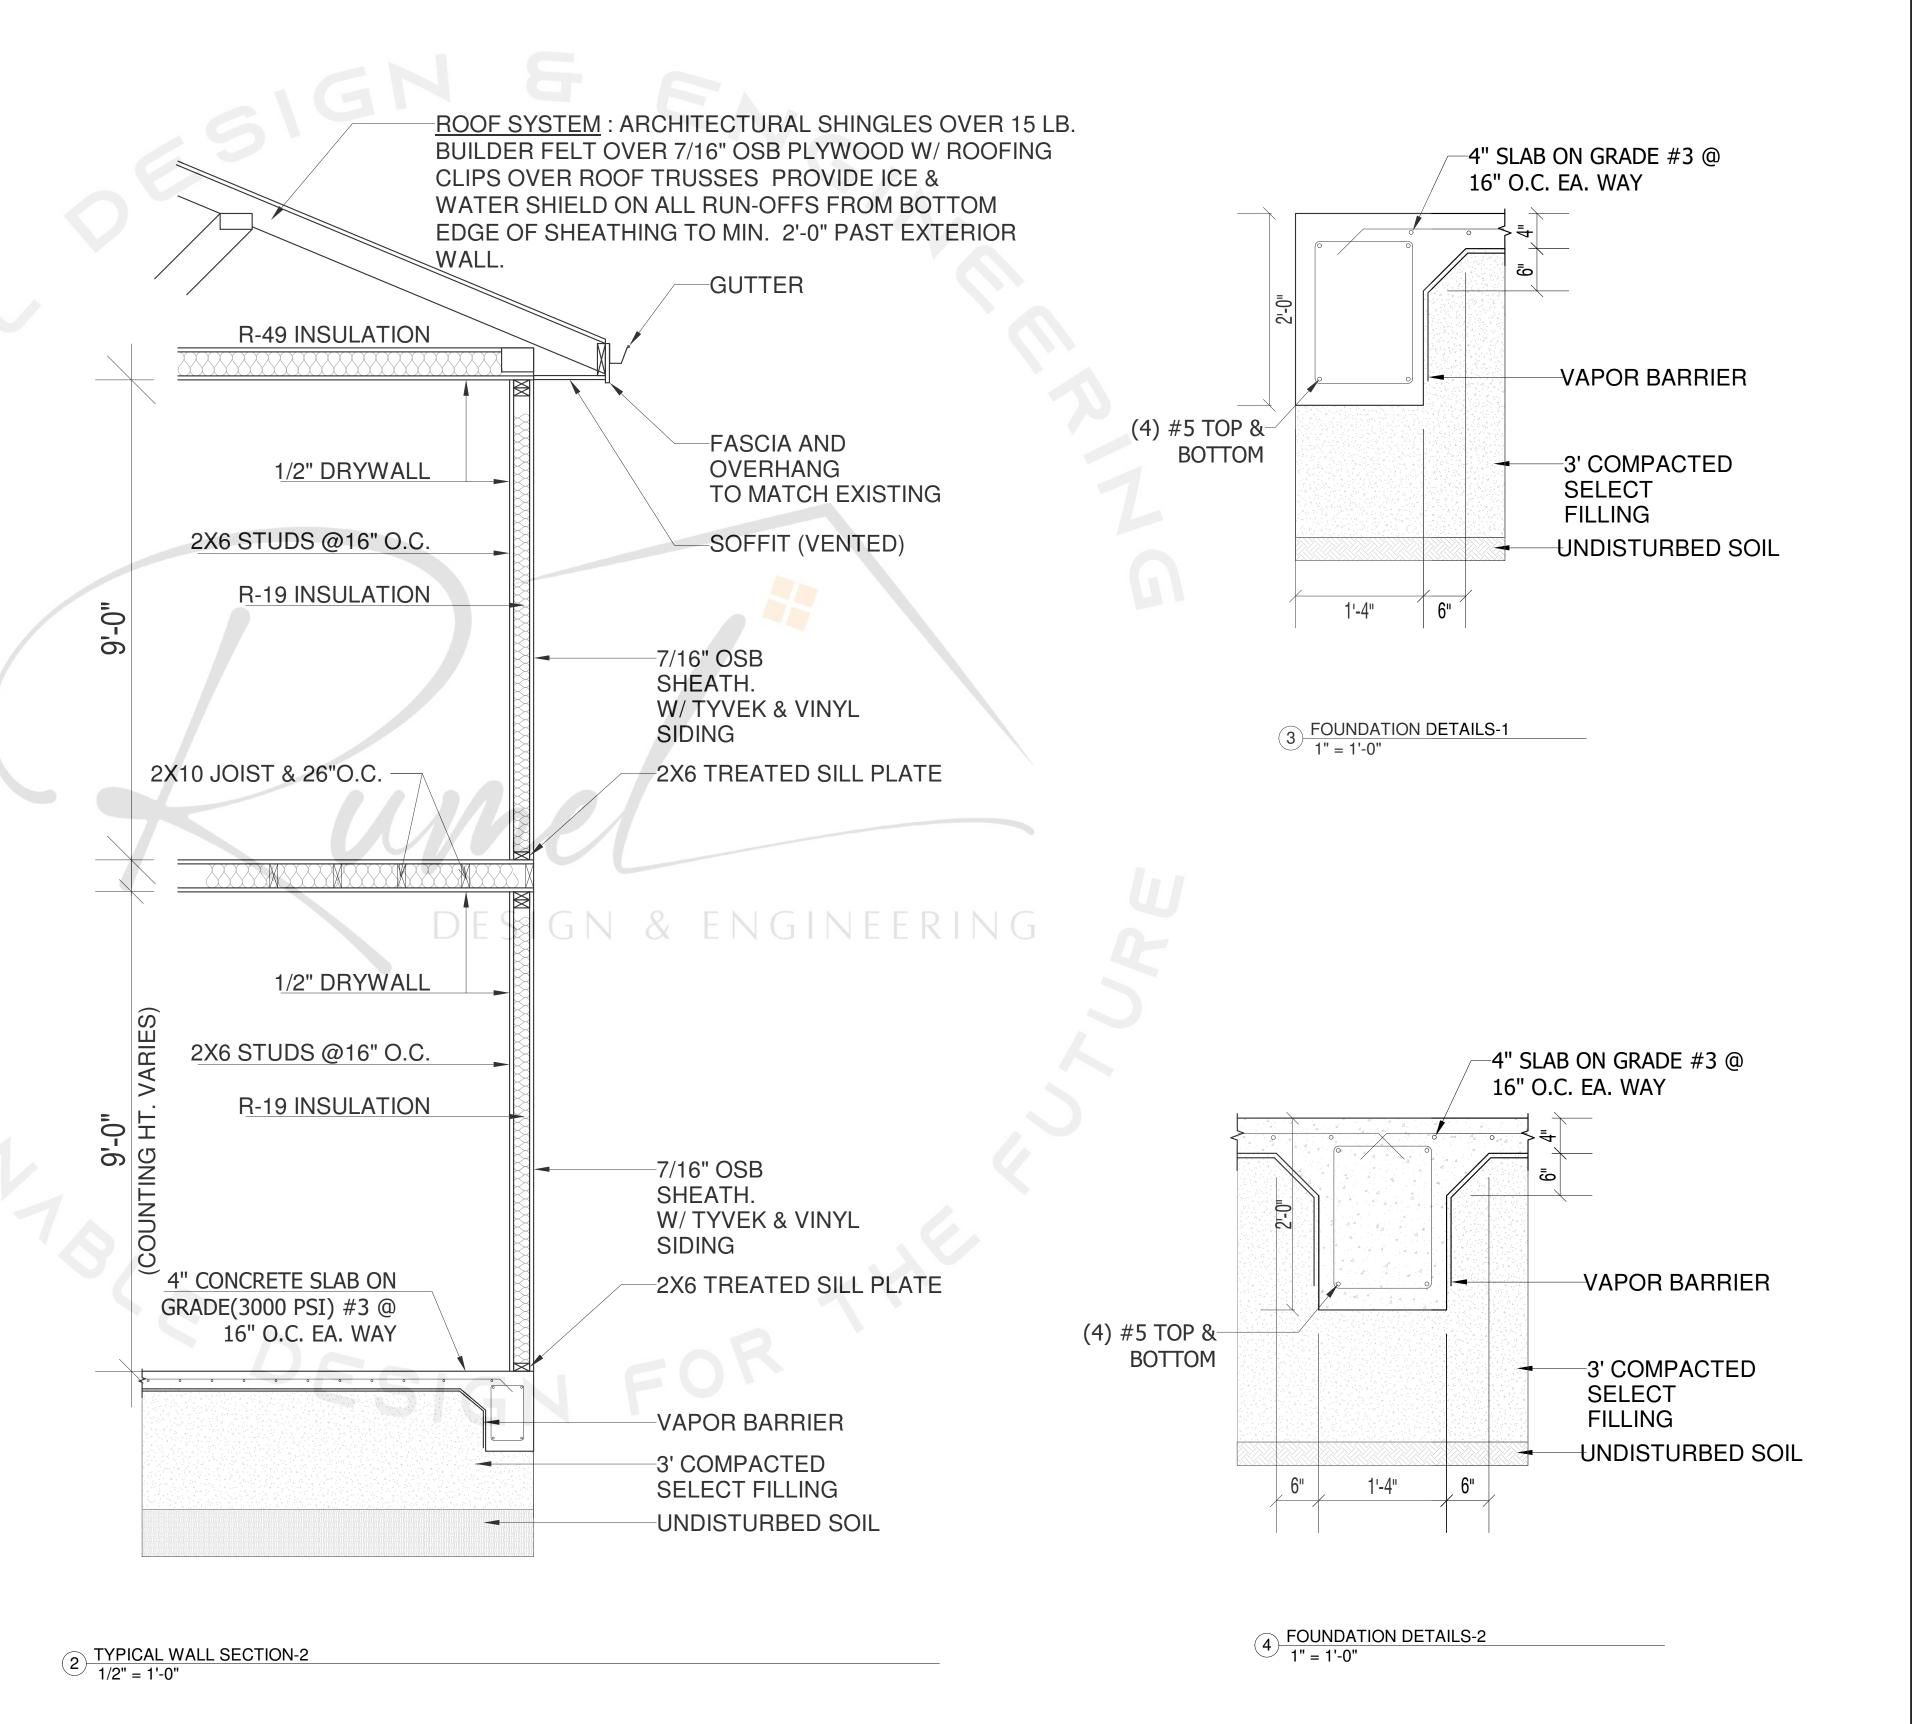

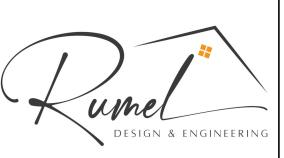

\*\*GET WHAT YOU ARE LOOKING FOR\*\*

© COPYRIGHT BY RUMEL DESIGN & ENGINEERING ALL RIGHTS RESERVED.

PLEASE NOTE: Rumel design & Engineering. assumes no liability for any structure constructed from this plan. It is the responsibility of the contractor to perform the following before beginning construction:

1) Contractor must verify ALL Dimensions on sheets and in field prior to proceeding with construction.

2) Contractor must verify compliance with ALL Local Building Codes in the area the project is to be constructed.

Plans indicate locations only, building engineering aspect should incorporate actual site conditions shown on a Survey provided by Owners Consultant

REVISION SCHEDULE:

NO. DESCRIPTION

DESCRIPTION DATE

PROJECT NUMBER:

PROJECT OWNERS:

CONTRACTOR:

SHEET TITLE:
TYPICAL WALL
SECTION

DRAWN BY:

'N BY: CHECKED BY: RDE

Project Status

DOCUMENT ISSUED 5/29/2025 10:06:19 PM

SCALE: As indicated

SHEET NO.

**S-2.0**